

TESLA

DRAWING INDEX

CHARGING STATION

11410 CENTURY OAKS TERRACE (TESLA STATION) AUSTIN TX 78758

		AUSTIN, TAT	0730			
SITE INFORMATION		APPLICABLE CODES	PROJECT DESCRIPTION		DRAWING INDE	
ADDRESS:	LATITUDE (NAVD88)	ALL WORK SHALL COMPLY WITH THE FOLLOWING APPLICABLE CODES:	INSTALL (8) TESLA CHARGING CABINETS		T-1	TITLE SHEET & PROJECT DATA
11410 CENTURY OAKS TERRACE (TESLA STATION) AUSTIN, TX 78758	N 30°24'10.26" 30.402850	2015 INTERNATIONAL BUILDING CODE WITH AMENDMENTS 2017 NATIONAL ELECTRICAL CODE WITH AMENDMENTS	INSTALL (16) 72KW TESLA CHARGING POSTS INSTALL (1) DISTRIBUTION PANEL INSTALL (8) AUTOTRANSFORMERS		CIVIL	SHEET T
POWER COMPANY:	LONGITUDE (NAVD88) W 97°43'29.23"		INSTALL (1) UTILITY TRANSFORMER	INSTALL (1) UTILITY TRANSFORMER		GENERAL NOTES
AUSTIN ENERGY	-97.724785	IN THE EVENT OF CONFLICT, THE MOST RESTRICTIVE CODE SHALL PREVAIL.	INSTALL (1) SERVICE ENTRANCE FUSED DIS	SCONNECT	GN-2	GENERAL NOTES
CONTACT: JON SANTOS (512) 505-7286	PERMITTING JURISDICTION:				GN-3	GENERAL NOTES
PROPERTY OWNER:						TOPOGRAPHIC SURVEY (BY OTHER
SIMON PROPERTY GROUP CONTACT: IRMA CASTOR	505 BARTON SPRINGS RD AUSTIN, TX 78704				C-1	OVERALL SITE PLAN
(512) 873-8099	·	DESIGN CRITERIA:			C-2	DEMOLITION PLAN
EQUIPMENT SUPPLIER:	CONTACT: CHRISTOPHER JOHNSON (512) 974-2769	WIND SPEED = 115 MPH 3-SECOND GUST, ULTIMATE			C-3	SITE PLAN - LEVEL 2
TESLA, INC. 3500 DEER CREEK RD	COUNTY:	EXPOSURE = C			C-4	GRADING PLAN
PALO ALTO, CA 94304	TRAVIS	CATEGORY = II FROST DEPTH = 10"			C-5	EQUIPMENT DIMENSION PLAN
(650) 681-5000					C-6	CIVIL DETAILS
GPD GROUP, PROFESSIONAL		LOCATION MAP	VICINITY M	/AP	C-7	CIVIL DETAILS
CORPORATION CONTACTS:					C-8	CIVIL DETAILS
PROJECT MANAGER: ZACHERY SHEETS. PE - OH# 77870			THE VILLAGE		C-9	CIVIL DETAILS CIVIL DETAILS
ZACHERY SHEETS, PE - OH# 77870 (330)572-2148 ZSHEETS@GPDGROUP.COM		Whole Foods Mark	e OF ANGUS CHAMPIONS VALLEY FOREST	WALNUT	C-10 P LANDSCAPE	SHEET T
PROJECT COORDINATOR:			dy's Country	CROSSING	L-1	TREE SURVEY AND ANALYSIS
TROY EVESLAGE, PE - IN# PE1150016 (317) 295-3179	64		re & Bar-BQ		L-1	TREE SURVEY AND ANALYSIS
TEVESLAGE@GPDGROUP.COM		0	MESA PARK	St. David's N Austin Medical Co	STRUCTURAL	SHEET T
UTILITY COORDINATOR: BRIAN GUTHRIDGE		Q Yard H			S-1	AUTOTRANSFORMER DETAILS
(330) 572-2249			Hyde Park High School 😜	***		
BGUTHRIDGE@GPDGROUP.COM PERMIT COORDINATOR:		ico de la companya della companya de	RY BALCONES ARK WOODS	Whole Foods Market	ELECTRICAL	SHEET T
ZACHARY WHITNEY (206) 204-7397		Domain NORTHSIDE 🚭			EN-1	ELECTRICAL GENERAL NOTES
ZWHITNEY@GPDGROUP.COM	6 O O	Alogo Domain NORTHSIDE O	QUARRY The Domain •	Apple Domain Northside	EN-2	ELECTRICAL GENERAL NOTES
	100 E	Apple Domain Northside Palm Way	The Domain 🖣	SITE	E-1	OVERALL UTILITY PLAN
		The Domain 🕲	STONELAKE	4H/75	E-2A	ELECTRICAL EQUIPMENT PLAN
		The Dollidin	OFFICE PARK		F 3B	ELECTRICAL EQUIDMENT DI ANI





GPD PROJECT NUMBER 2018441.22 DRAWN BY CHECKED BY: RP/EPM INSTALLATION MANAGER: ROBERT CORDOVA

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-		В	10.31.18	ISSUED FOR 100% REVIEW
		Α	10.02.18	ISSUED FOR 50% REVIEW
	1	REV	DATE	DESCRIPTION



INLESS THEY ARE ACTING UNDER THE DIRECTIO OF A LICENSED PROFESSIONAL ENGINEER, TO ALTER THIS DOCUMENT.

> 11410 CENTURY OAKS TERRACE (TESLA STATION) AUSTIN, TX 78758

> > SHEET TITLE

TITLE SHEET & PROJECT DATA

T-1




Call 2 Working Days Before You Dig

FLOOD HAZARD AREA NOTE

THE SITE IS LOCATED IN FLOOD ZONE "X" (AREA DETERMINED TO BE OUTSIDE THE 0.2% ANNUAL CHANCE FLOODPLAIN) PER FLOOD INSURANCE MAP NUMBER 48453C0265K, EFFECTIVE DATE - 01/06/2016.

BEFORE SCALING

CONTRACTORS SHALL VERIFY ALL PLANS, EXISTING DIMENSIONS, AND FIELD CONDITIONS ON THE JOB SITE AND SHALL IMMEDIATELY NOTIFY THE ENGINEER IN WRITING OF ANY DISCREPANCIES BEFORE PROCEEDING WITH THE WORK OR BE RESPONSIBLE FOR SAME

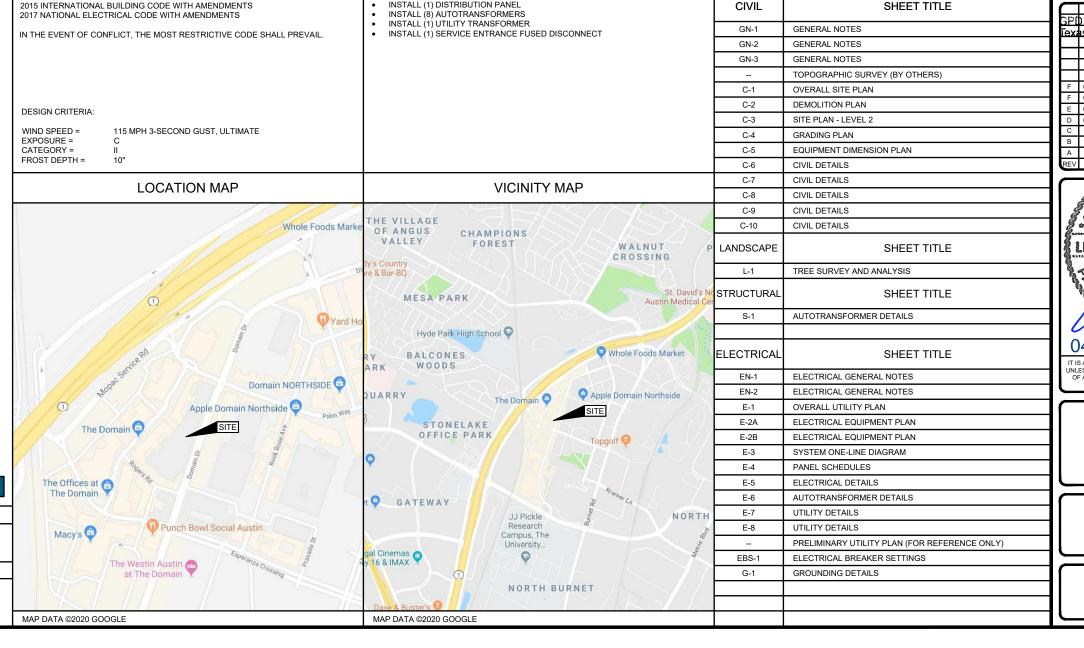

GENERAL CONSTRUCTION NOTES

- . FOR THE PURPOSE CONSTRUCTION DRAWINGS, THE FOLLOWING DEFINITIONS SHALL APPLY:
 GENERAL CONTRACTOR: TBD
 CONTRACTOR: TBD
 OWNER: TESLA
- THE TOPOGRAPHIC SURVEY BY CLARK, DATED 09/07/2018 SHALL BE CONSIDERED A PART OF THESE PLANS. THE G.C. IS RESPONSIBLE FOR LOCATING IMPROVEMENTS PER THESE PLANS.
- 3. THE LOCATIONS OF UNDERGROUND FACILITIES SHOWN ON THE PLAN ARE BASED ON FIELD SURVEYS AND CITY RECORDS. DUE TO THE LIMITATIONS IN TECHNOLOGY AND GROUND CONDITIONS, NOT ALL UNDERGROUND UTILITIES ARE ABLE TO BE LOCATED. IF AN EXISTING UTILITY LINE IS DAMAGED DURING CONSTRUCTION, IT SHALL BE DETERMINED IF SAID UTILITY LINE WAS ABLE TO BE LOCATED WITH CURRENT TECHNOLOGY BEFORE THE UTILITY LOCATES WOULD TAKE RESPONSIBILITY. IT SHALL BE THE CONTRACTOR'S FULL RESPONSIBILITY TO CONTACT THE VARIOUS UTILITY COMPANIES TO LOCATE THEIR FACILITIES PRIOR TO STARTING CONSTRUCTION. NO ADDITIONAL COMPENSATION SHALL BE PAID TO THE CONTRACTOR FOR DAMAGE AND REPAIR TO THESE FACILITIES CAUSED BY HIS WORK FORCE.
- 4. ALL DIMENSIONS, GRADES, AND UTILITY LOCATIONS SHOWN ON THESE PLANS WERE BASED ON A TOPOGRAPHIC SURVEY. THE CONTRACTOR SHALL FIELD VERIFY ALL EXISTING CONDITIONS PRIOR TO CONSTRUCTION. CONTRACTOR SHALL NOTIFY CONSTRUCTION/PROJECT MANAGER IF ANY DISCREPANCIES EXIST PRIOR TO PROCEEDING WITH CONSTRUCTION FOR NECESSARY CHANGES. NO EXTRA COMPENSATION SHALL BE PAID TO THE CONTRACTOR FOR WORK HAVING TO BE REDONE DUE TO INFORMATION SHOWN INCORRECTLY ON THESE PLANS IF SUCH NOTIFICATION HAS NOT BEEN GIVEN.
- 5. THE GENERAL CONTRACTOR SHALL VISIT THE SITE AND SHALL FAMILIARIZE THEMSELVES WITH ALL CONDITIONS AFFECTING THE PROPOSED WORK AND SHALL MAKE PROVISIONS. GENERAL CONTRACTOR SHALL BE RESPONSIBLE FOR FAMILIARIZING THEMSELVES WITH ALL CONTRACT DOCUMENTS, FIELD DOCUMENTS, DIMENSIONS, AND CONFIRMING THAT THE WORK MAY BE ACCOMPLISHED AS SHOWN PRIOR TO PROCEEDING WITH CONSTRUCTION. ANY DISCREPANCIES SHALL BE BROUGHT TO THE ATTENTION OF THE ENGINEER PRIOR TO THE COMMENCEMENT OF WORK
- 6. ALL MATERIALS FURNISHED AND INSTALLED SHALL BE IN STRICT ACCORDANCE WITH ALL APPLICABLE CODES, REGULATIONS, AND ORDINANCES. GENERAL CONTRACTOR SHALL ISSUES ALL APPROPRIATE NOTICES AND COMPLY WITH ALL LAWS, ORDINANCES, RULES, REGULATIONS, AND LAWFUL ORDERS OF ANY PUBLIC AUTHORITY REGARDING THE PERFORMANCE OF WORK.
- 7. ALL WORK CARRIED OUT SHALL COMPLY WITH ALL APPLICABLE MUNICIPAL AND UTILITY COMPANY SPECIFICATIONS AND LOCAL JURISDICTION CODES, ORDINANCES AND APPLICABLE REGULATIONS.
- UNLESS NOTED OTHERWISE, THE WORK SHALL INCLUDE FURNISHING MATERIALS, EQUIPMENT, APPURTENANCES, AND LABOR NECESSARY TO COMPLETE ALL INSTALLATIONS AS INDICATION ON THE DRAWINGS.
- 9. PLANS ARE NOT TO BE SCALED. THESE PLANS ARE INTENDED TO BE A DIAGRAMMATIC OUTLINE ONLY UNLESS OTHERWISE NOTED. DIMENSIONS SHOWN ARE TO FINISH SURFACES UNLESS OTHERWISE NOTED. SPACING BETWEEN EQUIPMENT IS THE MINIMUM REQUIRED CLEARANCE. THEREFORE, IT IS CRITICAL TO FIELD VERIFY DIMENSIONS, SHOULD THERE BE ANY QUESTIONS REGARDING THE CONTRACT DOCUMENTS, THE CONTRACTOR SHALL BE RESPONSIBLE FOR OBTAINING A CLARIFICATION FROM THE ENGINEER PRIOR TO PROCEEDING WITH THE WORK. DETAILS ARE INTENDED TO SHOW DESIGN INTENT. MODIFICATIONS MAY BE REQUIRED TO SUIT JOB DIMENSIONS OR CONDITIONS AND SUCH MODIFICATIONS SHALL BE INCLUDED AS PART OF WORK AND PREPARED BY THE ENGINEER PRIOR TO PROCEEDING WITH WORK.
- THE CONTRACTOR SHALL INSTALL ALL EQUIPMENT AND MATERIALS IN ACCORDANCE WITH MANUFACTURER'S RECOMMENDATIONS UNLESS SPECIFICALLY STATED OTHERWISE.
- 11. IF THE SPECIFIED EQUIPMENT CANNOT BE INSTALLED AS SHOWN ON THESE DRAWINGS, THE CONTRACTOR SHALL PROPOSE AN ALTERNATIVE INSTALLATION SPACE FOR APPROVAL BY THE ENGINEER PRIOR TO PROCEEDING.
- 12. THE GENERAL CONTRACTOR SHALL BE RESPONSIBLE FOR THE SAFETY OF WORK AREA, ADJACENT AREAS AND BUILDING OCCUPANTS THAT ARE LIKELY TO BE AFFECTED BY THE WORK UNDER THIS CONTRACT. WORK SHALL CONFORM TO ALL OSHA REQUIREMENTS AND THE LOCAL JURISDICTION.
- THE GENERAL CONTRACTOR SHALL COORDINATE WORK AND SCHEDULE WORK ACTIVITIES WITH OTHER DISCIPLINES.
- 14. CONSTRUCTION SHALL BE DONE IN A WORKMANLIKE MANNER BY COMPETENT EXPERIENCED WORKMAN IN ACCORDANCE WITH APPLICABLE CODES AND THE BEST ACCEPTED PRACTICE.
- 15. WORK PREVIOUSLY COMPLETED IS REPRESENTED BY LIGHT SHADED LINES AND NOTES. THE SCOPE OF WORK FOR THIS PROJECT IS REPRESENTED BY DARK SHADED LINES AND NOTES. CONTRACTOR SHALL NOTIFY THE GENERAL CONTRACTOR OF ANY EXISTING CONDITIONS THAT DEVIATE FROM THE DRAWINGS PRIOR TO BEGINNING CONSTRUCTION.
- THE CONTRACTOR SHALL PROVIDE WRITTEN NOTICE TO THE CONSTRUCTION MANAGER 48 HOURS PRIOR TO COMMENCEMENT OF WORK.
- 17. THE CONTRACTOR SHALL PROTECT EXISTING IMPROVEMENTS, PAVEMENTS, CURBS, LANDSCAPING AND STRUCTURES. ANY DAMAGED PART SHALL BE REPAIRED AT CONTRACTOR'S EXPENSE TO THE SATISFACTION OF THE OWNER.
- 18. THE CONTRACTOR SHALL CONTACT UTILITY LOCATING SERVICES PRIOR TO THE START OF CONSTRUCTION.
- THE GENERAL CONTRACTOR SHALL COORDINATE AND MAINTAIN ACCESS FOR ALL TRADES AND CONTRACTORS TO THE SITE AND/OR BUILDING.
- THE GENERAL CONTRACTOR SHALL BE RESPONSIBLE FOR SECURITY OF THE SITE FOR THE DURATION OF CONSTRUCTION UNTIL JOB COMPLETION.
- 21. THE GENERAL CONTRACTOR SHALL MAINTAIN IN GOOD CONDITION ONE COMPLETE SET OF PLANS WITH ALL REVISIONS ADDENDA AND CHANGE ORDERS ON THE PREMISES AT ALL TIMES.
- 22. THE GENERAL CONTRACTOR SHALL PROVIDE PORTABLE FIRE EXTINGUISHERS WITH A RATING OF NOT LESS THAN 2-A OT 2-A:10-B:C AND SHALL BE WITHIN 25 FEET OF TRAVEL DISTANCE TO ALL PORTIONS OF WHERE THE WORK IS BEING COMPLETED DURING CONSTRUCTION.

- 23. ALL EXISTING ACTIVE SEWER, WATER, GAS, ELECTRIC, AND OTHER UTILITIES SHALL BE PROTECTED AT ALL TIMES, AND WHERE REQUIRED FOR THE PROPER EXECUTION OF THE WORK, SHALL BE RELOCATED AS DIRECTED BY THE ENGINEER. EXTREME CAUTION SHOULD BE USED BY THE CONTRACTOR WHEN EXCAVATING OR DRILLING PIERS AROUND OR NEAR UTILITIES. THE CONTRACTOR SHALL PROVIDE SAFETY TRAINING FOR THE WORKING CREW. THIS SHALL INCLUDE BUT NOT BE LIMITED TO A) FALL PROTECTION, B) CONFINED SPACE, C) ELECTRICAL SAFETY, AND D) TRENCHING & EXCAVATION.
- 24. ONLY ITEMS SPECIFICALLY CALLED OUT TO BE REMOVED OR DEMOLISHED SHALL BE AFFECTED. ANY ITEMS INCLUDING, BUT NOT LIMITED TO, CURBS, PAVEMENT, UTILITY ITEMS, LANDSCAPING, ETC. SHALL REMAIN AND BE PROTECTED THROUGHOUT CONSTRUCTION. CONTRACTOR IS RESPONSIBLE TO REPAIR OR REPLACE ANY AFFECTED ITEMS AT OWNERS DISCRETION.
- 25. ALL EXISTING INACTIVE SEWER, WATER, GAS, ELECTRIC, AND OTHER UTILITIES, WHICH INTERFERE WITH THE EXECUTION OF THE WORK, SHALL BE REMOVED, CAPPED, PLUGGED OR OTHERWISE DISCONNECTED AT POINTS WHICH WILL NOT INTERFERE WITH THE EXECUTION OF THE WORK, AS DIRECTED BY THE ENGINEER, AND SUBJECT TO THE APPROVAL OF THE OWNER AND/OR LOCAL UTILITIES.
- 26. THE AREAS OF THE OWNER'S PROPERTY DISTURBED BY THE WORK AND NOT COVERED BY THE EQUIPMENT OR DRIVEWAY, SHALL BE GRADED TO A UNIFORM SLOPE, AND STABILIZED TO PREVENT EROSION
- 77. CONTRACTOR SHALL MINIMIZE DISTURBANCE TO THE EXISTING SITE DURING CONSTRUCTION. EROSION CONTROL MEASURES, IF REQUIRED DURING CONSTRUCTION, SHALL BE IN CONFORMANCE WITH THE FEDERAL AND LOCAL JURISDICTION FOR EROSION AND SEDIMENT CONTROL.
- NO FILL OR EMBANKMENT MATERIAL SHALL BE PLACED ON FROZEN GROUND. FROZEN MATERIALS, SNOW OR ICE SHALL NOT BE PLACED IN ANY FILL OR EMBANKMENT.
- 29. THE SUBGRADE SHALL BE BROUGHT TO A SMOOTH UNIFORM GRADE AND COMPACTED TO 95 PERCENT STANDARD PROCTOR DENSITY UNDER PAVEMENT AND STRUCTURES AND 80 PERCENT STANDARD PROCTOR DENSITY IN OPEN SPACE. ALL TRENCHES IN PUBLIC RIGHT OF WAY SHALL BE BACKFILLED WITH FLOWABLE FILL OR OTHER MATERIAL PRE-APPROVED BY THE LOCAL JURISDICTION.
- 30. ALL NECESSARY RUBBISH, STUMPS, DEBRIS, STICKS, STONES, AND OTHER REFUSE SHALL BE REMOVED FROM THE SITE AND DISPOSED OF IN A LAWFUL MANNER.
- 31. ALL BROCHURES, OPERATING AND MAINTENANCE MANUALS, CATALOGS, SHOP DRAWINGS, AND OTHER DOCUMENTS SHALL BE TURNED OVER TO THE GENERAL CONTRACTOR AT COMPLETION OF CONSTRUCTION AND PRIOR TO PAYMENT.
- 32. THE CONTRACTOR SHALL SUBMIT A COMPLETE SET OF AS-BUILT REDLINES TO THE GENERAL CONTRACTOR UPON COMPLETION OF PROJECT AND PRIOR TO FINAL PAYMENT.
- 3. THE CONTRACTOR SHALL LEAVE PREMISES IN A CLEAN CONDITION.
- 34. THE PROPOSED FACILITY WILL BE UNMANNED AND DOES NOT REQUIRE POTABLE WATER OR SEWER SERVICE, AND IS NOT FOR HUMAN HABITATION (NO HANDICAP ACCESS REQUIRED FOR SERVICE EQUIPMENT). HANDICAP ACCESS MAY BE REQUIRED FOR CHARGING POSTS. SEE PLAN.
- 35. NO OUTDOOR STORAGE OR SOLID WASTE CONTAINERS ARE PROPOSED
- CONTRACTORS SHALL BE RESPONSIBLE FOR OBTAINING ALL PERMITS AND INSPECTIONS REQUIRED FOR CONSTRUCTION. IF CONTRACTOR CANNOT OBTAIN A PERMIT, THEY MUST NOTIFY THE GENERAL CONTRACTOR IMMEDIATELY.
- 7. THE CONTRACTOR SHALL REMOVE ALL TRASH AND DEBRIS FROM THE SITE ON A DAILY BASIS.
- . INFORMATION SHOWN ON THESE DRAWINGS WAS OBTAINED FROM SITE VISITS AND/OR DRAWINGS PROVIDED BY THE SITE OWNER. CONTRACTORS SHALL NOTIFY THE ENGINEER OF ANY DISCREPANCIES PRIOR TO ORDERING MATERIAL OR PROCEEDING WITH CONSTRUCTION.

PROPOSED LEGEND SIGN ON POST CURB SIGN ON POST IN BOLLARD CURB AND GUTTER TRANSVERSE STRIPING LIGHT POLE PROPOSED CONCRETE Ф **METER** PROPOSED ASPHALT **CHARGING POST** PROPOSED RIVER ROCK \odot WATER MAIN **CHARGING CABINET** WATER LINE IRRIGATION LINE GAS LINE SERVICE ENTRANCE STORM LINE DISCONNECT SANITARY LINE ELECTRIC MAIN AUTOTRANSFORMERS ELECTRIC LINE ON FRAME — L/P — LIGHT POLE CONDUIT



TRAFFIC CONTROL NOTES (AS REQUIRED)

- DURING THE CONSTRUCTION PERIOD; SIDEWALKS, SHOULDERS, TRAVEL LANE(S), OR STREETS MAY HAVE TO BE TEMPORARILY CLOSED OR RESTRICTED FOR THE UNLOADING / LOADING OF EQUIPMENT OR AS A RESULT OF CONSTRUCTION ACTIVITIES THEMSELVES. IT IS THE CONTRACTOR'S RESPONSIBILITY TO COORDINATE DIRECTLY WITH THE LOCAL GOVERNING AUTHORITIES ON ANY SUCH CLOSURES AND MUST OBTAIN WRITTEN PERMISSION FROM THE APPROPRIATE AUTHORITIES PRIOR TO IMPLEMENTING SUCH CLOSURES OR RESTRICTIONS. ANY CLOSURE OR RESTRICTION MUST COMPLY WITH THE STATE MANUAL OF UNIFORM CONTROL DEVICES (MUTCD) FOR STREETS AND HIGHWAYS (LATEST EDITION AND REVISION), AND WITH ANY AND ALL ADDITIONAL APPLICABLE CITY, VILLAGE, OR COUNTY REQUIREMENTS. THE CONTRACTOR SHALL PREPARE AND SUBMIT A FORMAL TRAFFIC CONTROL / MOT PLAN TO THE LOCAL GOVERNING AUTHORITIES IF REQUESTED. ALL REQUIRED CONSTRUCTION TRAFFIC MAINTENANCE DEVICES SHALL BE PROVIDED, ERECTED AND MAINTAINED, AND UI IMMATELY REMOVED BY THE CONTRACTOR.
- THE CONTRACTOR SHALL MAINTAIN SAFE AND SATISFACTORY ACCESS TO ALL ABUTTING PROPERTIES AND INTERSECTING STREET AT ALL TIMES DURING THE CONSTRUCTION OF THE IMPROVEMENTS ANTICIPATED. DRIVEWAYS MUST BE MAINTAINED AND ALL TRENCHES SHALL BE BACKFILLED AT THE END OF EACH WORK DAY. PER THE STATE MUTCD AND OTHER APPLICABLE APPROPRIATE GOVERNING REQUIREMENTS, THE CONTRACTOR SHALL PROVIDE ALL NECESSARY SAFEGUARDS SUCH AS BARRICADES, SATISFACTORY BARRIERS, CONES, SIGNAGE, BARRELS, MESSAGE BOARDS, LIGHTING, FLAGMEN, LAW ENFORCEMENT OFFICERS, ETC. TO AVOID DAMAGE AND / OR INJURY TO VEHICLES AND PERSONS TRAVERSING THE CONSTRUCTION AREA.





GPD PROJECT NUMBER:	2018441.22
DRAWN BY:	HD
CHECKED BY:	RP/EPM
INSTALLATION MANAGER:	ROBERT CORDOVA

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F	03.31.20	SIGNED AND SEALED
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> 11410 CENTURY OAKS TERRACE (TESLA STATION) AUSTIN, TX 78758

> > SHEET TITLE

GENERAL NOTES

SHEET NUMBER

GN-1

GENERAL SITE WORK NOTES CONTINUED

PART 1 - GENERAL

CLEARING, GRUBBING, STRIPPING, EROSION CONTROL, SURVEY, LAYOUT, SUBGRADE PREPARATION AND FINISH GRADING AS REQUIRED TO COMPLETE THE PROPOSED WORK SHOWN IN THESE PLANS.

- (STATE DEPARTMENT OF TRANSPORTATION STANDARD SPECIFICATIONS FOR HIGHWAY CONSTRUCTION-CURRENT EDITION).
- ASTM (AMERICAN SOCIETY FOR TESTING AND MATERIALS).
- C. OSHA (OCCUPATION SAFETY AND HEALTH ADMINISTRATION)
- INSPECTION AND TESTING
- FIELD TESTING OF EARTHWORK COMPACTION AND CONCRETE CYLINDERS SHALL BE PERFORMED BY AN INDEPENDENT TESTING LAB. THIS WORK TO BE COORDINATED BY THE CONTRACTOR.
- ALL WORK SHALL BE INSPECTED AND RELEASED BY THE GENERAL CONTRACTOR WHO SHALL CARRY OUT THE GENERAL INSPECTION OF THE WORK WITH SPECIFIC CONCERN TO PROPER PERFORMANCE OF THE WORK AS SPECIFIED AND/OR CALLED FOR ON THE DRAWINGS. IT IS THE CONTRACTOR'S RESPONSIBILITY TO REQUEST TIMELY INSPECTIONS PRIOR TO PROCEEDING WITH FURTHER WORK THAT WOULD MAKE PARTS OF WORK INACCESSIBLE OR DIFFICULT TO INSPECT
- SITE MAINTENANCE AND PROTECTION:
- PROVIDE ALL NECESSARY JOB SITE MAINTENANCE FROM COMMENCEMENT OF WORK UNTIL COMPLETION OF THE CONTRACT.
- AVOID DAMAGE TO THE SITE AND TO EXISTING FACILITIES. STRUCTURES, TREES, AND SHRUBS DESIGNATED TO REMAIN. TAKE PROTECTIVE MEASURES TO PREVENT EXISTING FACILITIES THAT ARE NOT DESIGNATED FOR REMOVAL FROM BEING DAMAGED BY THE WORK
- KEEP SITE FREE OF ALL PONDING WATER
- PROVIDE EROSION CONTROL MEASURES IN ACCORDANCE WITH STATE DOT, LOCAL PERMITTING AGENCY AND EPA REQUIREMENTS.
- PROVIDE AND MAINTAIN ALL TEMPORARY FENCING. BARRICADES, WARNING SIGNALS AND SIMILAR DEVICES NECESSARY TO PROTECT AGAINST THEFT FROM PROPERTY DURING THE ENTIRE PERIOD OF CONSTRUCTION, REMOVE ALL SUCH DEVICES UPON COMPLETION OF THE WORK
- EXISTING UTILITIES: DO NOT INTERRUPT EXISTING UTILITIES SERVING FACILITIES OCCUPIED BY THE OWNER OR OTHERS, EXCEPT WHEN PERMITTED IN WRITING BY THE CONSTRUCTION MANAGER AND THEN ONLY AFTER ACCEPTABLE TEMPORARY UTILITY SERVICES HAVE BEEN PROVIDED.
- PROVIDE A MINIMUM 48-HOUR NOTICE TO THE CONSTRUCTION MANAGER AND RECEIVE WRITTEN NOTICE TO PROCEED BEFORE INTERRUPTING ANY UTILITY SERVICE.

PART 2 - PRODUCTS

- 2.1 GRANULAR BACKFILL: SHALL MEET THE FOLLOWING GRADATION
- 2.2 GRANULAR BEDDING AND TRENCH BACKFILL: WELL-GRADED SAND MEETING THE GRADATION REQUIREMENTS OF ASTM D2487 (SE OR SW-SM).
- UNSUITABLE MATERIAL: HIGH AND MODERATELY PLASTICS SILTS AND CLAYS (LL>45), MATERIAL CONTAINING REFUSE, FROZEN LUMPS, DEMOLISHED BITUMINOUS MATERIAL, VEGETATIVE MATTER, WOOD, STONES IN EXCESS OF 3 INCHES IN ANY DIMENSION, AND DEBRIS AS DETERMINED BY THE CONSTRUCTION MANAGER. TYPICAL THESE WILL BE SOILS CLASSIFIED BY ASTM AS PT, MH, CH, OH, ML. AND OL

SIEVE SIZE	TOTAL PERCENT PASSING
1 1/2 INCH (37.5 MM)	100
1 INCH (25.0 MM)	75 TO 100
3/4 INCH (19.00 MM)	80 TO 100
3/8 INCH (9.5 MM)	35 TO 75
NO. 4 (4.75 MM)	30 TO 60
NO. 30 (0.600 MM)	7 TO 30
NO. 200 (0.75 MM)	3 TO 15

PART 3 - EXECUTION

3.1 GENERAL

- BEFORE STARTING GENERAL SITE PREPARATION ACTIVITIES, INSTALL EROSION AND SEDIMENT CONTROL MEASURES. THE WORK AREA SHALL BE CONSTRUCTED AND MAINTAINED IN SUCH CONDITION THAT IN THE EVENT OF RAIN THE SITE WILL BE DRAINED AT ALL TIMES.
- BEFORE ALL SURVEY, LAYOUT, STAKING, AND MARKING, ESTABLISH AND MAINTAIN ALL LINES, GRADES, ELEVATIONS AND BENCHMARKS NEEDED FOR EXECUTION OF THE WORK.
- CLEAR AND GRUB THE AREA WITHIN THE LIMITS OF THE SITE, REMOVE TREES, BRUSH, STUMPS RUBBISH AND OTHER DEBRIS AND VEGETATION RESTING ON OR PROTRUDING THROUGH THE SURFACE OF THE SITE AREA TO BE CLEARED.
- REMOVE THE FOLLOWING MATERIALS TO A DEPTH OF NO LESS THAN 12 INCHES BELOW THE ORIGINAL GROUND SURFACE: ROOTS, STUMPS, AND OTHER DEBRIS, BRUSH, AND REFUSE EMBEDDED IN OR PROTRUDING THROUGH THE GROUND SURFACE, RAKE, DISK OR PLOW THE AREA TO A DEPTH OF NO LESS THAN 6 INCHES, AND REMOVE TO A DEPTH OF 12 INCHES ALL ROOTS AND OTHER DEBRIS
- REMOVE TOPSOIL MATERIAL COMPLETELY FROM THE SURFACE UNTIL THE SOIL NO LONGER MEETS

- THE DEFINITION OF TOPSOIL. AVOID MIXING TOPSOIL WITH SUBSOIL OR OTHER UNDESIRABLE
- F. EXCEPT WHERE EXCAVATION TO GREATER DEPTH IS INDICATED, FILL DEPRESSIONS RESULTING FROM CLEARING, GRUBBING AND DEMOLITION WORK COMPLETELY WITH SUITABLE FILL.
- G. REMOVE FROM THE SITE AND DISPOSE IN AN AUTHORIZED LANDFILL ALL DEBRIS RESULTING FROM CLEARING AND GRUBBING OPERATIONS, BURNING WILL NOT BE PERMITTED.
- PRIOR TO EXCAVATING, THOROUGHLY EXAMINE THE AREA TO BE EXCAVATED AND/OR TRENCHED TO VERIFY THE LOCATIONS OF FEATURES INDICATED ON THE DRAWINGS AND TO ASCERTAIN THE EXISTENCE AND LOCATION OF ANY STRUCTURE UNDERGROUND STRUCTURE OR OTHER ITEM NOT SHOWN THAT MIGHT INTERFERE WITH THE PROPOSED CONSTRUCTION. NOTIFY THE CONSTRUCTION MANAGER OF ANY OBSTRUCTIONS THAT WILL PREVENT ACCOMPLISHMENT OF THE WORK AS INDICATED ON THE DRAWINGS
- SEPARATE AND STOCK PILE ALL EXCAVATED MATERIALS SUITABLE FOR BACKFILL. ALL EXCESS EXCAVATED AND UNSUITABLE MATERIALS SHALL BE DISPOSED OF OFF-SITE IN A LEGAL MANNER
- DURING EXCAVATION. THE CONTRACTOR SHALL PROVIDE SHORING. SHEETING, AND BRACING AS REQUIRED TO PREVENT CAVING OR SLOUGHING OF EXCAVATION.
- K. THE BASE OF ALL FOUNDATION EXCAVATIONS SHOULD BE FREE OF WATER AND LOOSE SOIL PRIOR TO PLACING CONCRETE CONCRETE SHOULD BE PLACED AS SOON AS POSSIBLE AFTER EXCAVATING TO MINIMIZE BEARING SOIL DISTURBANCE. SHOULD THE SOILS AT BEARING LEVEL BECOME EXCESSIVELY DRY, SATURATED, DISTURBED OR OTHERWISE ALTERED, THE AFFECTED SOIL SHOULD BE REMOVED PRIOR TO PLACING CONCRETE.

3.2 BACKFILL

- A. AS SOON AS PRACTICAL. AFTER COMPLETING CONSTRUCTION OF THE RELATED STRUCTURE, INCLUDING EXPIRATION OF THE SPECIFIED MINIMUM CURING PERIOD FOR CAST-IN-PLACE CONCRETE, BACKFILL THE EXCAVATION WITH APPROVED MATERIAL TO RESTORE THE REQUIRED
- B. PRIOR TO PLACING BACKFILL AROUND STRUCTURES, ALL FORMS SHALL BE REMOVED AND THE EXCAVATION CLEANED OF ALL TRASH, DEBRIS, AND UNSUITABLE MATERIALS
- C. DO NOT PLACE FROZEN MATERIAL IN AS BACKFILL.
- D. BACKFILL BY PLACING AND COMPACTING SUITABLE BACKFILL MATERIAL OR SELECT GRANULAR BACKFILL MATERIAL WHEN REQUIRED IN UNIFORM HORIZONTAL LAYERS OF NO GREATER THAN 8-INCHES LOOSE THICKNESS AND COMPACTED. WHERE HAND OPERATED COMPACTORS ARE USED THE FILL MATERIAL SHALL BE PLACED IN LIFTS NOT TO EXCEED 4 INCHES IN LOOSE DEPTH AND
- E. WHENEVER THE DENSITY TESTING INDICATES THAT THE CONTRACTOR HAS NOT OBTAINED THE SPECIFIED DENSITY, THE SUCCEEDING LAYER SHALL NOT BE PLACED UNTIL THE SPECIFICATION REQUIREMENTS ARE MET UNLESS OTHERWISE AUTHORIZED BY THE CONSTRUCTION MANAGER. THE CONTRACTOR SHALL TAKE WHATEVER APPROPRIATE ACTION IS NECESSARY, SUCH AS DISKING AND DRYING. ADDING WATER. OR INCREASING THE COMPACTIVE EFFORT TO MEET THE MINIMUM COMPACTION REQUIREMENTS
- F. THOROUGHLY COMPACT EACH LAYER OF BACKFILL TO A MINIMUM OF 95 PERCENT OF THE MAXIMUM DRY DENSITY AS PROVIDED BY THE STANDARD PROCTOR TEST, ASTM D 698.
- A. UTILITY TRENCHES SHALL BE EXCAVATED TO THE LINES AND GRADES SHOWN ON THE DRAWINGS OR AS DIRECTED BY THE GENERAL CONTRACTOR. PROVIDE SHORING, SHEETING AND BRACING AS REQUIRED TO PREVENT CAVING OR SLOUGHING OF THE TRENCH WALLS.
- B. EXTEND THE TRENCH WIDTH A MINIMUM OF 6 INCHES BEYOND THE OUTSIDE EDGE OF THE OUTERMOST
- C. WHEN SOFT YIELDING, OR OTHERWISE UNSTABLE SOIL CONDITIONS ARE ENCOUNTERED, EXCAVATE THE REQUIRED TRENCH TO A DEPTH OF NO LESS THAN 12 INCHES BELOW THE REQUIRED ELEVATION, THEN BACKFILL WITH 12" OF GRANULAR BEDDING MATERIAL.

3.4 TRENCH BACKFILL:

- PROVIDE GRANULAR BEDDING MATERIAL IN ACCORDANCE WITH THE DRAWINGS AND THE UTILITY REQUIREMENTS
- B. NOTIFY THE GENERAL CONTRACTOR 24 HOURS IN ADVANCE OF BACKFILLING.
- C. CONDUCT UTILITY CHECK TESTS BEFORE BACKFILLING. BACKFILL AND COMPACT TRENCH BEFORE
- D. PLACE GRANULAR TRENCH BACKFILL UNIFORMLY ON BOTH SIDES OF THE CONDUITS IN 6-INCH UNCOMPACTED LIFTS UNTIL 12 INCHES OVER THE CONDUITS. SOLIDLY RAM AND TAMP BACKFILL INTO
- E. PROTECT CONDUIT FROM LATERAL MOVEMENT, IMPACT DAMAGE, OR UNBALANCED LOADING.
- F. ABOVE THE CONDUIT EMBEDMENT ZONE, PLACE AND COMPACT SATISFACTORY BACKFILL MATERIAL IN I-INCH MAXIMUM LOOSE THICKNESS LIFTS TO RESTORE THE REQUIRED FINISHED SURFACE GRADE.
- G. COMPACT FINAL TRENCH BACKELL TO A DENSITY FOLIAL TO OR GREATER THAN THAT OF THE EXISTING UNDISTURBED MATERIAL IMMEDIATELY ADJACENT TO THE TRENCH BUT NO LESS THAN A MINIMUM OF 95 PERCENT OF THE MAXIMUM DRY DENSITY AS PROVIDED BY THE STANDARD PROCTOR TEST, ASTM D
- 3.5 FINISH GRADING:
- A. PERFORM ALL GRADING TO PROVIDE POSITIVE DRAINAGE AWAY FROM STRUCTURES AND SMOOTH EVEN SURFACE DRAINAGE OF THE ENTIRE AREA WITHIN THE LIMITS OF CONSTRUCTION. GRADING SHALL BE COMPATIBLE WITH ALL SURROUNDING TOPOGRAPHY AND STRUCTURES.
- B. UTILIZE SATISFACTORY FILL MATERIAL RESULTING FROM THE EXCAVATION WORK IN THE

- CONSTRUCTION OF FILLS, EMBANKMENTS AND FOR REPLACEMENT OF REMOVED UNSUITABLE MATERIALS
- C. REPAIR ALL ACCESS ROADS AND SURROUNDING AREAS USED DURING THE COURSE OF THIS WORK TO THEIR ORIGINAL CONDITION.
- 3.6 ASPHALT PAVING:
- CONTRACTOR RESPONSIBLE FOR RE-STRIPING AND APPLYING SEALCOATING PER LOCAL DO SPECIFICATIONS, UNLESS OTHERWISE SPECIFIED.

SIGN POST NOTES.

- 1. ACCEPTABLE COLOR SUBSTITUTIONS:
- 2. OTHER ACCEPTABLE COLORS CAN BE FOUND ON ENCYCOLORPEDIA.COM

D. CONTRACTOR TO GRADE SITE TO DRAIN AND NOT POND WATER.

CONTRACTOR SHALL COORDINATE WITH CITY WHEN SPECIAL JURISDICTIONAL/CITY REQUESTS ARE NECESSARY FOR ANY SIGN POST INSTALLATIONS, I.E. POST MATERIAL, PAINT COLORS, HARDWARE ETC. CONTRACTOR IS RESPONSIBLE FOR ENSURING CITY APPROVES ALL MATERIALS PRIOR TO INSTALLATION.

PAINT COLOR SUBSTITUTIONS		
COLOR		
COOL GRAY #7 #a6a19e		
FUSION / Af-675 #a6a3a1		
EQUINOX FF31-1 #9fa29d		
STAMPED CONCRETE - 7655 #a2a29b		
STONE MASON GRAY #a19c99		

LANDSCAPE/IRRIGATION NOTES

- ALL DISTURBED AND PROPOSED LANDSCAPE AREAS SHALL RECEIVE 3" OF ORGANIC MULCH TO MATCI EXISTING CONDITIONS.
- 2. PLANT GUARANTEE (IF APPLICABLE): CONTRACTOR SHALL GUARANTEE ALL PLANTS FOR A PERIOD OF ONE (1) YEAR FROM DATE OF PROJECT ACCEPTANCE BY THE OWNER
- IRRIGATION RELOCATION: CONTRACTOR FIELD VERIFY IF EXISTING IRRIGATION IS PRESENT DETERMINE POINT OF CONNECTION, SYSTEM PRESSURE, FIXTURE TYPES, AND POTENTIAL FOF EXPANSION. IF FOUND THAT THE EXISTING IRRIGATION SYSTEM IS CAPABLE OF EXPANSION AND REUSE THAN IT SHALL BE MODIFIED TO PROVIDE 100% COVERAGE OF THE LANDSCAPE AREA IF THE EXISTING IRRIGATION SYSTEM IS NOT CAPABLE OF EXPANSION, CONTRACTOR TO INSTALL A NEW CONTROLLER BOOSTER PUMP, AND OTHER APPARATUSES NEEDED FOR A COMPLETE IRRIGATION SYSTEM IRRIGATED AREAS SHALL BE IRRIGATED BY DRIP IRRIGATION OR SIMILAR FIXTURES BY THE SAME SUPPLIER, CONTRACTOR SHALL ENSURE, BUILDING WALLS AND WINDOWS WILL NOT BE DAMAGED OR STAINED BY IMPROPER IRRIGATION INSTALLATION OR POOR SELECTION OF FIXTURES. SYSTEM SHALI INCLUDE ALL SPRINKLER FIXTURES, DRIP TUBING, PIPING, VALVES, WIRING AND CONTROLS TO PROVIDE A COMPLETE FUNCTIONAL SYSTEM THAT SHALL COMPLY WITH CITY CODE. PRIOR TO UPDATING THE IRRIGATION SYSTEM, A CERTIFIED IRRIGATION DESIGNER SHALL PROVIDE SHOP DRAWINGS TO ENGINEER FOR APPROVAL. UPON APPROVAL OF SHOP DRAWINGS, THE UPDATED IRRIGATION SYSTEM SHALL BE APPROVED BY OWNER FOR FINAL ACCEPTANCE






330.572.2100 Fax: 330.572.2102 GPD PROJECT NUMBER 2018441.22

RP/EPN CHECKED BY INSTALLATION MANAGER: ROBERT CORDOV

GPD Group, Professional Corpora Texas Registration No. 16477 F 04.17.20 SIGNED AND SEALED 03.31.20 SIGNED AND SEALED E 07.25.19 SIGNED AND SEALED D 03.08.19 ISSUED FOR 100% REVIEW C 12.06.18 ISSUED FOR 100% REVIEW B 10.31.18 ISSUED FOR 100% REVIEW A 10.02.18 ISSUED FOR 50% REVIEW REV DATE DESCRIPTION

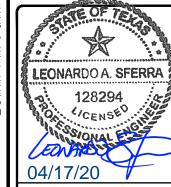

IT IS A VIOLATION OF THE LAW FOR ANY PERSON INLESS THEY ARE ACTING UNDER THE DIRECTIO OF A LICENSED PROFESSIONAL ENGINEER, TO ALTER THIS DOCUMENT

> 11410 CENTURY OAKS TERRACE (TESLA STATION) AUSTIN, TX 78758

> > SHEET TITLE

GENERAL NOTES

SHEET NUMBER

GN-2

GOVERNING BUILDING CODE:

GOVERNING BUILDING CODE: 2015 INTERNATIONAL BUILDING CODE WITH AMENDMENTS

DESIGN LOADINGS:

GRAVITY LOADS:		
FLOOR DEAD LOADS	UNIFORM	CONCENTRATE
MECHANICAL SLABS	125 PSF	2000 LBS
FLOOR LIVE LOADS		
MECHANICAL SLABS	40 PSF	
SNOW LOADS:		
GROUND SNOW LOAD (Pg)	5 PSF	
LATERAL LOAD DESIGN DATA:		
WIND DESIGN DATA (ASCE 7-10):		
BASIC WIND SPEED (V _{ult})	115 MPH	
BASIC WIND SPEED (Vasd)	89 MPH	
IMPORTANCE FACTOR	1.0	
EXPOSURE CATEGORY	С	
SEISMIC DESIGN DATA (ASCE 7-10):		
SEISMIC IMPORTANCE FACTOR (I)	1.0	
RISK CATEGORY	II	
SITE CLASS	D (ASSUM	ED)
MAPPED SPECTRAL RESPONSE	0.063	
SHORT PERIODS (Ss) 1 SEC. PERIODS (S₁)	0.063	
SPECTRAL RESPONSE COEFF.	0.034	
SHORT PERIODS (Sps)	0.068	
1 SEC. PERIODS (S _{D1})	0.054	
SEISMIC DESIGN CATEGORY	А	

GENERAL PROVISIONS:

TYPICAL DETAILS AND GENERAL NOTES APPLY TO ALL PARTS OF THE WORK EXCEPT WHERE SPECIFICALLY DETAILED OR UNLESS OTHERWISE NOTED.

DRAWINGS ARE NOT TO BE SCALED.

THE CONTRACTOR SHALL CAREFULLY REVIEW THE DRAWINGS TO IDENTIFY THE SCOPE OF WORK REQUIRED, VISIT THE SITE TO RELATE THE SCOPE OF WORK TO EXISTING CONDITIONS, AND DETERMINE THE EXTENT OF WHICH THOSE CONDITIONS AND PHYSICAL SURROUNDINGS WILL IMPACT THE WORK

EXISTING CONDITIONS, AS SHOWN ON THESE PLANS, ARE FOR REFERENCE ONLY. THE CONTRACTOR IS REQUIRED TO FIELD VERIFY ALL EXISTING CONDITIONS PRIOR TO CONSTRUCTION

THE CONTRACTOR SHALL ASSUME THE MOST STRINGENT REQUIREMENTS APPLY IN CASE OF CONFLICT AMONG SPECIFICATIONS, STANDARDS, CODES AND DRAWINGS. THE CONTRACTOR SHALL NOTIFY THE ARCHITECT/ENGINEER IMMEDIATELY TO RESOLVE THE CONFLICT.

ANY DEVIATION, MODIFICATION, OR SUBSTITUTION FROM THE BID SET OF STRUCTURAL DRAWINGS SHALL BE SUBMITTED TO THE ARCHITECT AND ENGINEER FOR REVIEW/APPROVAL PRIOR TO ITS USE OR INCLUSION ON THE SHOP DRAWINGS. WITHOUT SUCH PRIOR APPROVAL, DEVIATIONS, MODIFICATIONS, OR SUBSTITUTIONS WILL BE REJECTED. COSTS FOR DEMOLITION AND REWORK OF SUCH ITEMS WILL BE BORNE BY THE CONTRACTOR.

THE STRUCTURE IS DESIGNED TO BE SELF-SUPPORTING AND STABLE AFTER IT IS FULLY COMPLETED FOR IN-SERVICE LOADS ONLY. THE MEANS, METHODS, PROCEDURES, AND SEQUENCES OF CONSTRUCTION ARE THE SOLE RESPONSIBILITY OF THE CONTRACTOR, WHICH INCLUDE THE DETERMINATION OF ALLOWABLE CONSTRUCTION LOADING OF THE STRUCTURE. THE CONTRACTOR SHALL PROVIDE, DESIGN, MONITOR, AND MAINTAIN ALL NECESSARY TEMPORARY AND PERMANENT SYSTEMS (SHORING, BRACING, GUYS, FALSEWORK, FORMWORK, SHEETING, ETC.) TO ENSURE THE INTEGRITY OF THE STRUCTURE AT ALL STAGES OF CONSTRUCTION. ANY SYSTEMS SHOWN ON THE DOCUMENTS ARE PARTIAL AND SCHEMATIC IN NATURE AND EXTENTS ARE NOT ALL INCLUSIVE. ALL WORK SHALL BE PERFORMED WITHOUT DAMAGE TO ADJACENT EXISTING WORK.

THE CONTRACTOR IS RESPONSIBLE FOR SITE SAFETY. THE CONTRACTOR AND ALL SUBCONTRACTORS SHALL REVIEW THE STRUCTURAL CONTRACT DOCUMENTS AND SHALL NOTIFY THE STRUCTURAL ENGINEER OF ANY CONFLICTS BETWEEN THOSE DOCUMENTS AND ANY SAFETY REGULATIONS. SUCH REVIEW AND NOTIFICATION SHALL OCCUR PRIOR TO PRODUCTION OF SHOP DRAWINGS.

THE CONTRACTOR SHALL PROTECT ALL WORK, MATERIALS, AND EQUIPMENT FROM DAMAGE AND SHALL PROVIDE PROPER STORAGE FACILITIES FOR MATERIALS AND EQUIPMENT DURING CONSTRUCTION.

SITE VISITS PERFORMED BY THE ARCHITECT/ENGINEER DO NOT INCLUDE INSPECTIONS OF MEANS AND METHODS OF CONSTRUCTION PERFORMED BY THE CONTRACTOR.

STRUCTURAL OBSERVATIONS PERFORMED BY THE ARCHITECT/ENGINEER DURING CONSTRUCTION ARE NOT THE CONTINUOUS AND SPECIAL INSPECTION SERVICES AND DO NOT WAIVE THE RESPONSIBILITY FOR THE INSPECTIONS REQUIRED OF THE BUILDING DEPARTMENT INSPECTOR OR THE TESTING AGENCY. ALSO, OBSERVATIONS DO NOT GUARANTEE THE CONTRACTOR'S PERFORMANCE AND SHALL NOT BE CONSIDERED AS SUPERVISION OF CONSTRUCTION.

NO STRUCTURAL ELEMENTS ARE TO BE CUT UNLESS SPECIFICALLY APPROVED BY THE ENGINEER

FOUNDATION SYSTEMS:

GENERAL:

THE CONTRACTOR SHALL VISIT THE SITE PRIOR TO THE START OF ANY WORK. THE CONTRACTOR SHALL VERIFY ANY EXISTING FIELD CONDITION THAT MAY AFFECT THE INSTALLATION OF THE FOLINDATION SYSTEM

THE CONTRACTOR SHALL EXERCISE GREAT CARE DURING EXCAVATION. UNDERGROUND UTILITY LOCATIONS, IF SHOWN, ARE APPROXIMATE. THE CONTRACTOR SHALL PREDETERMINE UTILITY LOCATIONS AND NOTIFY THE ENGINEER IMMEDIATELY IF DEVIATION FROM PLANS EXIST. THE CONTRACTOR IS RESPONSIBLE FOR THE SAFE SUPPORT OF UTILITIES ACROSS EXCAVATIONS.

SHEETING, SHORING, AND DEWATERING IS THE RESPONSIBILITY OF THE CONTRACTOR.

NO GEOTECHNICAL REPORT WAS PROVIDED AT THE TIME OF FOUNDATION DESIGN. A SOILS TESTING LABORATORY SHALL BE RETAINED BY THE OWNER TO PROVIDE CONSTRUCTION REVIEW TO ENSURE CONFORMANCE WITH THE CONSTRUCTION DOCUMENTS DURING THE EXCAVATIONS, BACKFILL, AND FOUNDATION PHASES OF THE PROJECT.

SPREAD/TRENCH FOOTINGS:

DETERMINATION OF FINAL BEARING ELEVATIONS, TOPSOIL AND EXCAVATION STRIPPING DEPTH, INSPECTION OF ALL SUBSOIL EXPOSED DURING STRIPPING, SITE GRADING, EXCAVATION OPERATIONS, APPROVAL OF FILL MATERIALS, DENSITY TESTING OF FILLS TO ENSURE PLACEMENT PER SPECIFICATION REQUIREMENTS, INSPECTION OF FOUNDATION BEARING SURFACES, AND VERIFICATION OF ALLOWABLE BEARING PRESSURES ARE THE TESTING LABORATORY'S RESPONSIBILITY.

ALL FOUNDATIONS ARE TO REST ON FIRM UNDISTURBED SOIL OR COMPACTED FILL FREE FROM ORGANIC MATTER. IF POOR SOIL CONDITIONS ARE ENCOUNTERED AT FOUNDATION DEPTHS SHOWN, NOTIFY OWNER'S REPRESENTATIVE BEFORE PROCEEDING WITH CONSTRUCTION.

CONTRACTOR SHALL COMPACT SUBGRADE. SEE FROST/NO FROST DESIGN NOTES BELOW.

FOUNDATIONS HAVE BEEN DESIGNED BASED ON AN ASSUMED ALLOWABLE SOIL BEARING CAPACITY OF 1500 PSF

NEW FOOTINGS PLACED ADJACENT TO EXISTING FOOTINGS SHALL BEAR AT THE SAME ELEVATION, UNI ESS NOTED OTHERWISE

STEP FOOTINGS AT A RATIO OF ONE (1) VERTICAL TO TWO (2) HORIZONTAL WITH A MAXIMUM VERTICAL STEP OF 2'-0" LINE SS NOTED OTHERWISE

INUNDATION AND LONG TERM EXPOSURE OF BEARING SURFACES, WHICH WILL RESULT IN DETERIORATION OF BEARING FORMATIONS, SHALL BE PREVENTED. FOOTINGS SHALL BE PLACED IMMEDIATELY FOLLOWING FOOTING EXCAVATIONS AND BEARING SURFACE INSPECTION.

UTILITY LINES SHALL NOT BE PLACED THROUGH OR BELOW FOUNDATIONS WITHOUT THE APPROVAL OF THE ENGINEER OF RECORD

GROUNDWATER ASSUMED TO BE BELOW EXCAVATION DEPTH. IF GROUNDWATER IS ENCOUNTERED DURING EXCAVATION ON SITE, CONTRACTOR SHALL PROVIDE FOR ANY SITE DRAINAGE AND DE-WATERING REQUIRED.

CONTRACTOR TO VERIFY LOCATION OF ALL EXISTING PUBLIC AND PRIVATE UTILITIES PRIOR TO EXCAVATION. IF NECESSARY, UTILITIES SHALL BE RELOCATED PRIOR TO FOUNDATION INSTALLATION.

CHARGING CABINET PRE-FABRICATED ASSEMBLY FOUNDATION & ALL CHARGING POST FOUNDATIONS - FROST DESIGN NOTES (I.E. BOTTOM OF FOUNDATION ABOVE FROST LEVEL):

CONCRETE FOUNDATIONS SHOULD BEAR DIRECTLY ON A PROPERLY COMPACTED FREE-DRAINING GRANULAR FILL CONSISTING OF NO. 57 STONE OR AN APPROVED EQUIVALENT.

GRANULAR FILL SHOULD EXTEND VERTICALLY TO THE MINIMUM RECOMMENDED REGIONAL FROST DEPTH AND LATERALLY 2/3D FROM THE FOUNDATION PERIMETER (EXCLUDING SIDE OF PERIMETER ADJACENT TO CURB). GRANULAR FILL SHOULD BE PLACED IN 8 INCH LOOSE LIFTS AND COMPACTED WITH A VIBRATORY COMPACTOR. THE COMPACTION EQUIPMENT SHOULD BE OPERATED OVER THE FULL WIDTH OF THE FOUNDATION UNDERCUT AREA UNTIL VISIBLE DEFORMATION OF THE BACKFILL CEASES. SEE SHEET T-1 FOR LOCAL FROST DEPTH.

GEOTEXTILE (FILTER FABRIC) SHOULD BE PLACED BETWEEN THE GRANULAR BACKFILL AND COHESIVE SOILS TO PRECLUDE THE INFILTRATION OF FINES.

CHARGING CABINET PRE-FABRICATED ASSEMBLY FOUNDATION & ALL CHARGING POST FOUNDATIONS - NO FROST DESIGN NOTES (I.E. BOTTOM OF FOUNDATION BELOW FROST LEVEL):

CONCRETE FOUNDATIONS SHOULD BE SUPPORTED ON A 6 INCH COMPACTED LAYER OF APPROVED FREE-DRAINING GRANULAR MATERIAL.

APPROVED MATERIAL SHOULD BE COMPACTED OVER THE FULL WIDTH OF THE INFILL AREA UNTIL VISIBLE DEFORMATION OF THE BACKFILL CEASES.

SPECIAL INSPECTIONS:

THE CONTRACTOR SHALL BE RESPONSIBLE FOR SCHEDULING AND OVERSEEING OF ALL SPECIAL INSPECTIONS REQUIRED BY THE AUTHORITY HAVING JURISDICTION. SPECIAL INSPECTIONS MUST BE COMPLETED PRIOR TO FINAL INSPECTION APPROVAL.

EXISTING SLAB REINFORCEMENT INVESTIGATION/X-RAY:

CONTRACTOR SHALL VERIFY POST TENSIONING AND REINFORCEMENT LOCATION IN EXISTING CONCRETE SLAB PRIOR TO DRILLING

CONCRETE:

GENERAL:

ALL CONCRETE CONSTRUCTION SHALL CONFORM TO ACI 301-10, "STANDARD SPECIFICATION FOR STRUCTURAL CONCRETE" AND ACI 302, 305 AND 306 UNLESS NOTED OTHERWISE.

ALL DETAILING, FABRICATION AND PLACING OF CONCRETE SHALL CONFORM TO ACI 318-14, "BUILDING CODE REQUIREMENTS FOR STRUCTURAL CONCRETE" AND THE LATEST ACI "MANUAL OF STANDARD PRACTICE FOR DETAIL REINFORCED CONCRETE STRUCTURES" UNLESS NOTED OTHERWISE

SAFETY AND PERFORMANCE OF THE STRUCTURE ARE THE RESPONSIBILITY OF THE CONTRACTOR INSOFAR AS THEY ARE AFFECTED BY THE LOCATION AND DETAILS OF CONSTRUCTION JOINTS. SHOP DRAWINGS OF THE PROPOSED CONSTRUCTION JOINT LOCATIONS AND DETAILS ARE TO BE SUBMITTED TO THE ARCHITECT FOR APPROVAL.

MAXIMUM SIZE OF AGGREGATE SHALL NOT EXCEED SIZE SUITABLE FOR INSTALLATION METHOD UTILIZED OR 1/3 CLEAR DISTANCE BEHIND OR BETWEEN REINFORCING. MAXIMUM SIZE MAY BE INCREASED TO 2/3 CLEAR DISTANCE PROVIDED WORKABILITY AND METHODS OF CONSOLIDATION SUCH AS VIBRATING WILL PREVENT HONEYCOMBS OR VOIDS.

ALL CONCRETE SHALL DEVELOP A MINIMUM COMPRESSIVE STRENGTH IN 28 DAYS AS FOLLOWS:

ALL CONCRETE - 4000 PSI

ALL CONCRETE EXPOSED TO WEATHER SHALL CONTAIN 6% (± 1%) AIR ENTRAINMENT

REINFORCING BARS SHALL CONFORM TO ASTM A615, GRADE 60

WELDED WIRE FABRIC REINFORCING SHALL CONFORM TO ASTM A1064 AND BE FURNISHED IN FLAT SHEETS AND INSTALLED ON CHAIRS OR PRECAST CONCRETE BLOCKS.

NO TACK WELDING OF REINFORCING IN THE FIELD IS PERMITTED.

PROVIDE CORNER BARS AT ALL LOCATIONS WHERE REINFORCEMENT CHANGES DIRECTION.

PROVIDE STRAIGHT AND DIAGONAL BARS AT EDGES OF ALL OPENINGS.

REINFORCING EMBEDMENT AND LAP SPLICES (INCHES) FOR 4000 PSI CONCRETE

	OTHER		TOP*		
BAR SIZE	ANCHORAGE	SPLICE	ANCHORAGE	SPLICE	
# 3	15	19	19	24	
# 4	19	25	25	33	
# 5	24	31	31	41	
# 6	29	37	37	49	

^{*} HORIZONTAL BARS WITH MORE THAN 12" OF CONCRETE BELOW BAR

NON-SHRINK GROUT SHALL MEET A MINIMUM 28-DAY COMPRESSIVE STRENGTH OF 6000 PSI.

STRUCTURAL STEEL

GENERAL:

MATERIAL PROPERTIES:

PLATE: ASTM A36 UNO

 PIPE:
 ASTM A53, TYPE E OR S, GRADE B

 TUBE:
 ASTM A500 GRADE B (Fy = 46 KSI)

DETAILING, FABRICATION, AND ERECTION SHALL CONFORM TO THE 2010 AISC (360-10) SPECIFICATIONS.

ALL WELDING SHALL BE DONE USING E-70XX ELECTRODES IN ACCORDANCE WITH AWS D1.1 SPECIFICATIONS.

FIELD VERIFY ALL CONDITIONS AT AND CONNECTIONS TO THE EXISTING CONSTRUCTION BEFORE FABRICATION.

ALL EXPOSED STRUCTURAL STEEL, ANCHOR RODS AND BOLTS SHALL BE HOT DIP GALVANIZED PER ASTM A123.

UNLESS NOTED OTHERWISE ON THE DRAWING, ALL ANCHOR RODS SHALL CONFORM TO ASTM F1554 WITH HEAVY HEXAGONAL NUT.

SUBMIT FABRICATION AND ERECTION DRAWINGS SHOWING ALL DETAILS, CONNECTIONS, MATERIAL DESIGNATIONS, AND TOP STEEL ELEVATIONS FOR APPROVAL. THE SHOP DRAWINGS WILL BE REVIEWED FOR GENERAL CONFORMANCE TO THE CONTRACT DRAWINGS. SUCH APPROVAL SHALL NOT RELIEVE THE FABRICATOR/CONTRACTOR OF THE RESPONSIBILITY FOR EITHER THE ACCURACY OF THE DETAILED DIMENSIONS IN THE SHOP AND ERECTION DRAWINGS OR THE GENERAL FIT-UP OF PARTS THAT ARE TO BE ASSEMBLED IN THE FIELD.



3500 DEER CREEK RD PALO ALTO, CA 94304 (650) 681-5000



 GPD PROJECT NUMBER:
 2018441.22

 DRAWN BY:
 HD

 CHECKED BY:
 RP/EPM

INSTALLATION MANAGER: ROBERT CORDOV

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			 Professional Corpor
	ě	as Keg	istration No. 16477
	F	04.17.20	SIGNED AND SEALED
	F	03.31.20	SIGNED AND SEALED
	Е	07.25.19	SIGNED AND SEALED
	D	03.08.19	ISSUED FOR 100% REVIEW
	С	12.06.18	ISSUED FOR 100% REVIEW
	В	10.31.18	ISSUED FOR 100% REVIEW
	Α	10.02.18	ISSUED FOR 50% REVIEW
	REV	DATE	DESCRIPTION



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ALTER THIS DOCUMENT.


11410 CENTURY OAKS TERRACE (TESLA STATION) AUSTIN, TX 78758

SHEET TITLE

GENERAL NOTES

SHEET NUMBER

GN-3

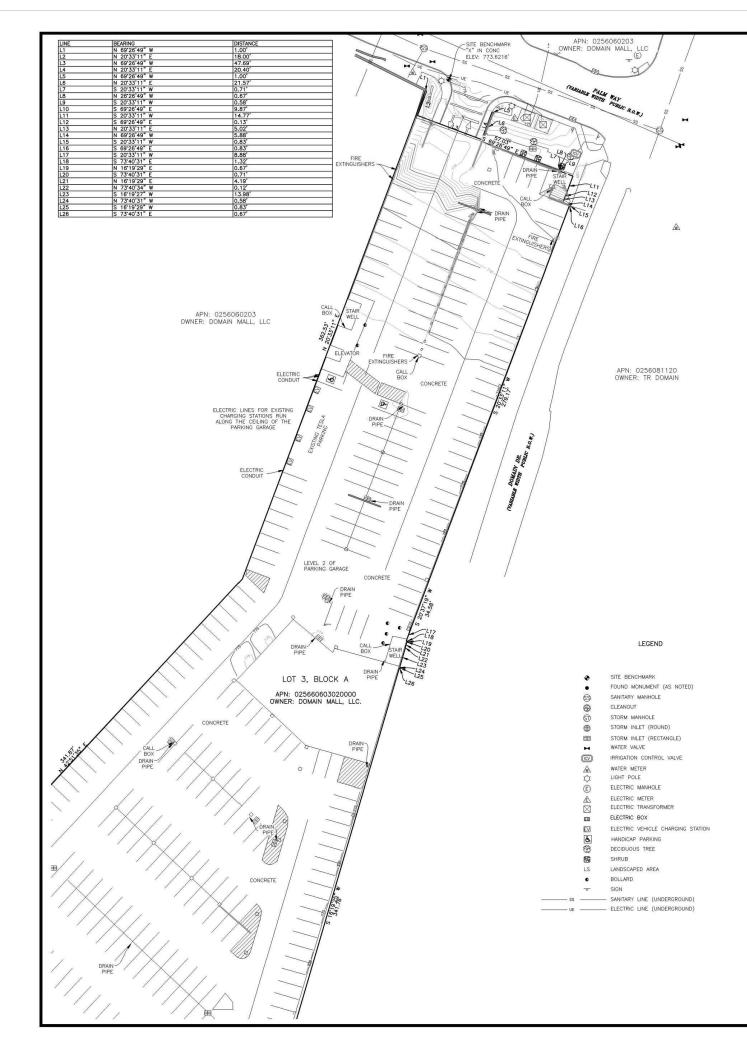

PROPERTY DESCRIPTION:

3.247 Acre portion of lot 3 block A, domain section 2 subdivision, document number 200030333 of Travis county, Tx. official plat records.

VICINITY MAP

SCHEDULE B2 EXCEPTIONS:

- 1.) CONDOMINIUM DECLARATION 03/06/2006 DOCUMENT NO. 2006039179 NOT PROVIDED AMENDMENT 01/03/2008 DOC. NO. 200800767 AMENDMENT 03/14/2008 DOC. NO. 200840798 NOT PROVIDED -AFFECTS SURVEY AREA, BLANKET IN NATURE
- 2.) ALL MATTER SHOWN ON PLAT 03/06/2006 DOC. NO 2006038809 AMENDED 03/12/2008 DOC. NO. 2008039054 -AFFECTS SURVEY AREA, BLANKET IN NATURE

Items not listed above are determined non-survey related items and are not plotted hereon.

NOTES:

- Any underground utilities shown have been located from field survey information. The surveyor makes no guarantee that the underground utilities shown comprise all such utilities in the area, either in service or abandoned. The surveyor further does not warrant that the underground utilities shown are in the exact location indicated although he does certify that they are located as accurately as possible from the information available.
- FEDERAL EMERGENCY MANAGEMENT AGENCY, Flood Insurance Rate Map, Map Number 48453C0265K effective date January 6, 2016, indicates this parcel of land is located in Zone X (Areas of 0.2% annual chance flood plain).
- 4. This survey does not constitute a title search by Clark Land Surveying, Inc. to determine ownership or easements of record. For all information regarding easements, rights of way and title of record, Clark Land Surveying, Inc. relied upon a Search Report, prepared by Hollerbach&Associztes, Inc. with an order number of HA269044, dated 08/20/2018.
- 5. Elevations are based on NAVD 88 datum.
- 6. BENCHMARK: Chiseled "x" in concrete, as shown. Elevation: 773.6216' (NAVD 88).
- BASIS OF BEARINGS: Bearings are relative to those shown upon the plat of the Domain Condominium, according to the map or plat thereof document number 200030333, recorded in of the Official Public Records of Travis County, Texas.
- 8. Field work for this survey was completed on August 30, 2018.
- 9. This site is zoned "MI-PDA" (Major Industrial Planned Development Area) per City of Austin, Tx. Planning Department.

Inis site is zoned Mi-PUA (Major industrial Planned Development Area) per City of Austin, IX. Planning Department Building Setbacks, refer to the Planned Development.

No zoning information provided by the client. Zoning setbacks shown hereon are the interpretation of the surveyor. For clarification of exact zoning designations and setback locations, please, contact the City of Austin Planning and Zoning Department at (S12) 978-4000.

SURVEYOR'S STATEMENT:

On the basis of my knowledge, information and belief, I hereby state and declare that this drawing was prepared under my direct supervision to the standard of care of surveyors practicing in the State of Texas and that the information shown hereon is true and correct to the best of my knowledge and belief.


This statement is neither a warranty nor a guarantee, either expressed or implied.





GRAPHIC SCALE FOR REFERENCE ONLY NOT TO SCALE (IN FEET) 1 inch = 30 ft.

SITE NAME: AUSTIN, TX THE J.T. CHAMBERS
T NUMBER 7
VIS COUNTY TOPOGRAPHIC S
A PORTION OF THE J.T.
ABSTRACT NUMBEI
AUSTIN, TRAVIS COUN 180996

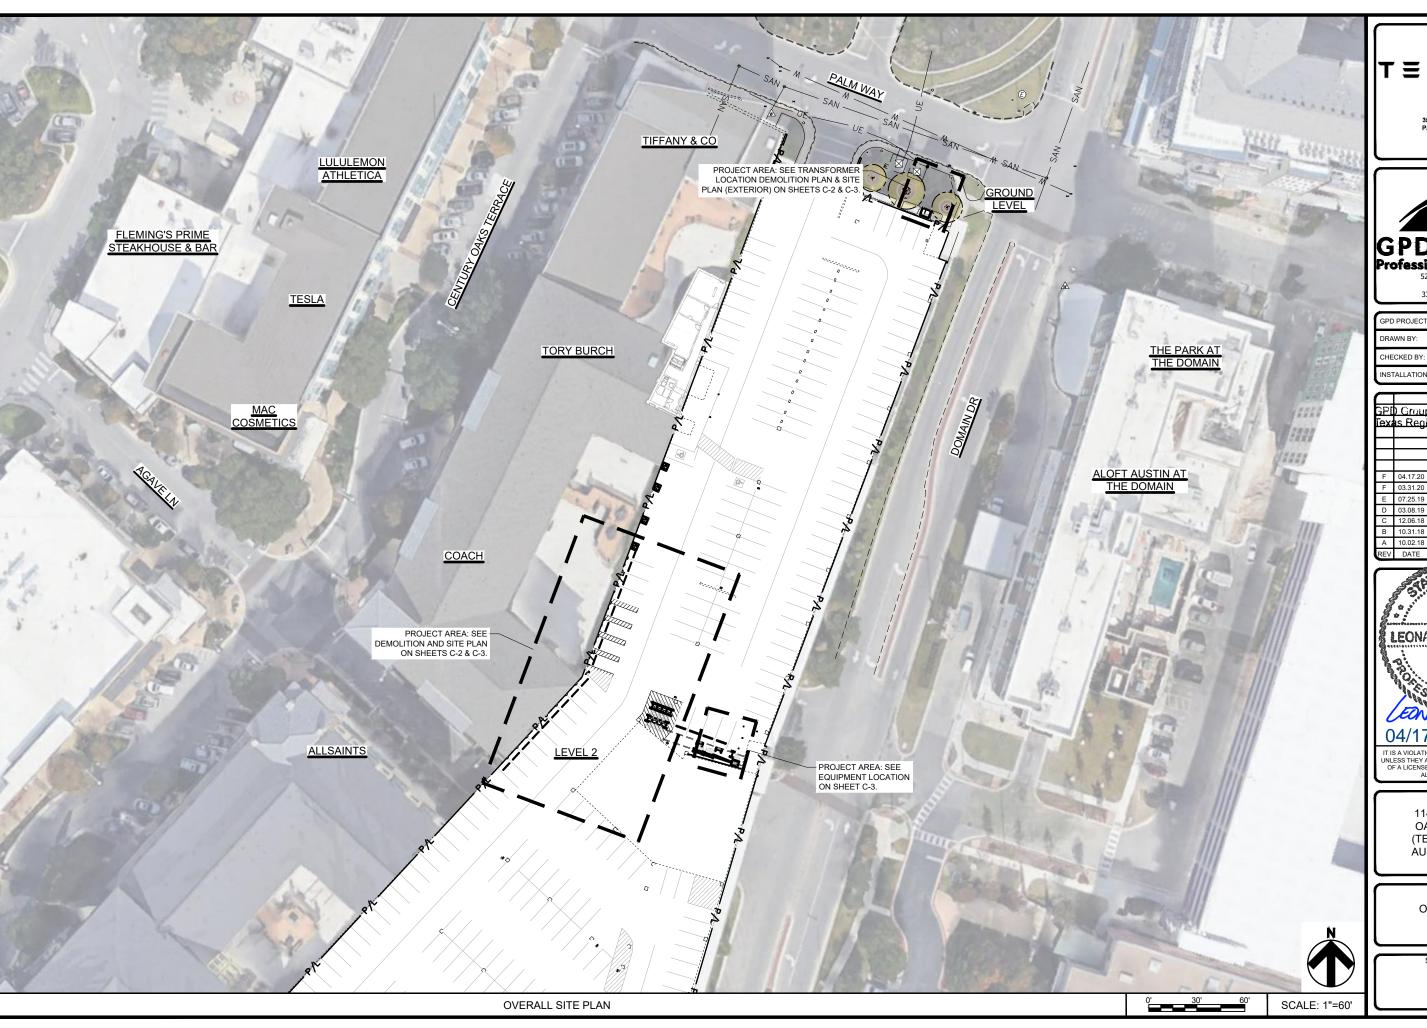



3500 DEER CREEK RD PALO ALTO, CA 94304 (650) 681-5000




2018441.22

GPD PROJECT NUMBER:

RP/EPM

INSTALLATION MANAGER: ROBERT CORDOVA

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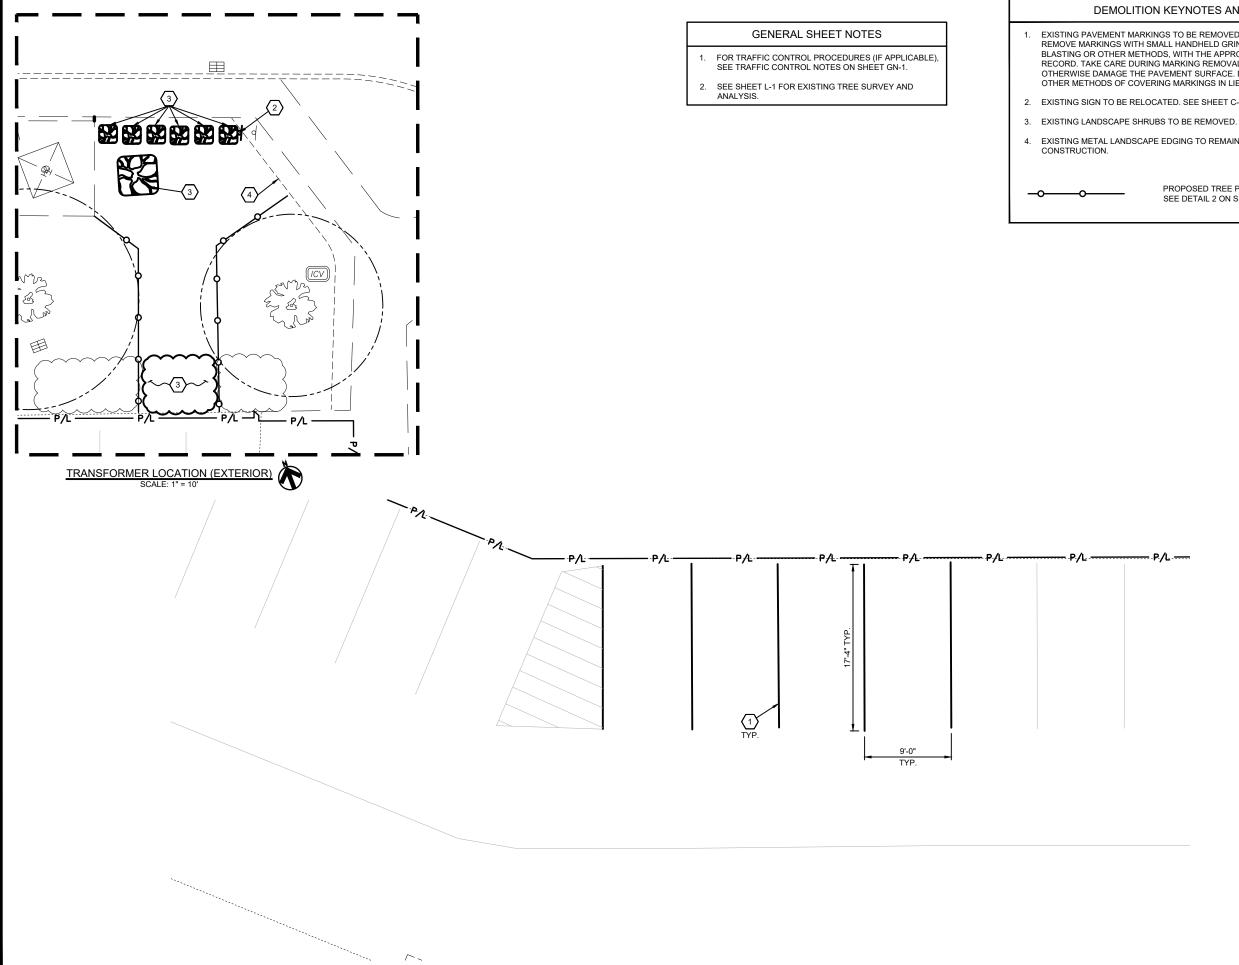
11410 CENTURY OAKS TERRACE (TESLA STATION) AUSTIN, TX 78758

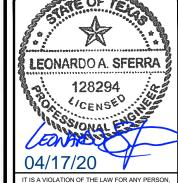SHEET TITLE

OVERALL SITE PLAN

SHEET NUMBER

C-1



DEMOLITION PLAN



- EXISTING PAVEMENT MARKINGS TO BE REMOVED. CONTRACTOR SHALL REMOVE MARKINGS WITH SMALL HANDHELD GRINDERS, SCARIFIERS, BEAD BLASTING OR OTHER METHODS, WITH THE APPROVAL OF THE ENGINEER OF RECORD. TAKE CARE DURING MARKING REMOVAL TO NOT SCAR, DISCOLOR, OR OTHERWISE DAMAGE THE PAVEMENT SURFACE. DO NOT OVER PAINT OR USE OTHER METHODS OF COVERING MARKINGS IN LIEU OF REMOVAL.
- 2. EXISTING SIGN TO BE RELOCATED. SEE SHEET C-3 FOR PROPOSED LOCATION.
- 4. EXISTING METAL LANDSCAPE EDGING TO REMAIN PROTECTED THROUGHOUT

PROPOSED TREE PROTECTION FENCE, SEE DETAIL 2 ON SHEET C-6




3500 DEER CREEK RD PALO ALTO, CA 94304 (650) 681-5000



520 South Main Street, Suite 2531 Akron, OH 44311 330.572.2100 Fax: 330.572.2102

DRAWN BY:	HD
CHECKED BY:	RP/EPM
INSTALLATION MANAGER:	ROBERT CORDOVA

GPI Tex) Group	Professional Corpora stration No. 16477	
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11410 CENTURY OAKS TERRACE (TESLA STATION) AUSTIN, TX 78758

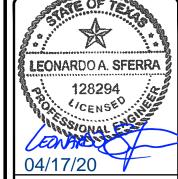
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DEMOLITION PLAN

SHEET NUMBER


C-2

SCALE: 1"=20'

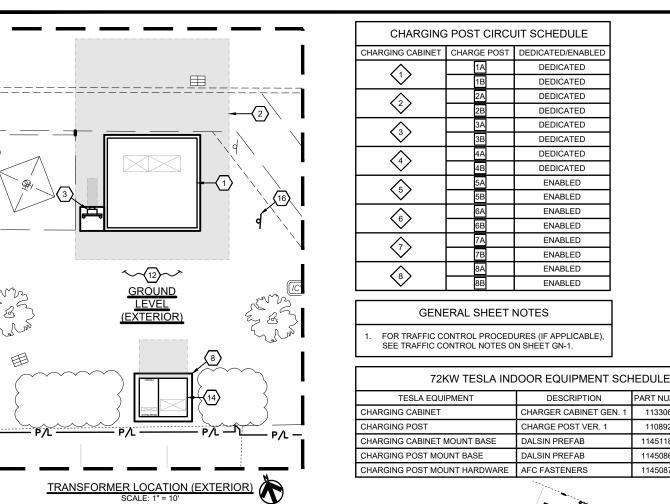

LEVEL 2

ENLARGEMENT A (LEVEL 2) SCALE: 1" = 5'

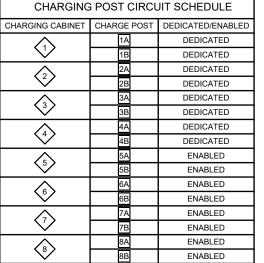

SITE PLAN - LEVEL 2

1.	PROPOSED PAD MOUNTED ELECTRICAL UTILITY TRANSFORMER (BY UTILITY).
	CONTRACTOR SHALL PROVIDE CONCRETE PAD PER UTILITY
	SPECIFICATIONS. COORDINATE FINAL LOCATION WITH UTILITY. SEE
	ELECTRICAL PLANS FOR PROPOSED ROUTING.

- 2. PROPOSED EQUIPMENT CLEAR SPACE (TYPICAL).
- PROPOSED ELECTRIC METER MOUNTED TO H-FRAME PER ELECTRIC COMPANY SPECIFICATIONS AND DETAILS ON ELECTRICAL SHEETS.
- PROPOSED DISTRIBUTION PANEL ON 4" HIGH HOUSEKEEPING PAD. SEE DETAIL ON SHEET C-7 AND ELECTRICAL DRAWINGS.
- PROPOSED TESLA CHARGE POST (TYPICAL OF 16). SEE DETAILS ON SHEET
- PROPOSED TESLA NON-ILLUMINATED WALL-MOUNTED PARKING SIGN (TYPICAL OF 16). SEE DETAILS ON SHEET C-6. SEE CHARGING POST
- PROPOSED TESLA CHARGING CABINET ON MOUNT BASE (TYPICAL OF 8). SEE DETAILS ON SHEET C-7 & C-8.
- PROPOSED CONCRETE PAD. SEE DETAIL ON SHEET C-7.
- PROPOSED AUTOTRANSFORMERS ON FRAME (TYPICAL OF 8). SEE DETAILS ON SHEET S-1 AND ELECTRICAL SHEETS.

- 10. PROPOSED PAINTED 4" WIDE WHITE TRANSVERSE STRIPING. STRIPING SHALL BE 3'-0" O.C. SEE DETAIL ON SHEET C-6.
- 11. PROPOSED U-BOLLARD (TYPICAL OF 10). SEE DETAILS ON SHEET C-9 AND C-10.
- 12. ALL DISTURBED AREAS NOT TO BE PAVED SHALL BE MULCHED PER
- 13. PROPOSED 4" HIGH HOUSEKEEPING PAD. SEE DETAIL ON SHEET C-7.
- 14. PROPOSED SERVICE ENTRANCE DISCONNECT PER ELECTRICAL DRAWINGS ON 4" HIGH HOUSEKEEPING PAD. SEE DETAILS ON SHEET C-7.
- 15. PROPOSED RUBBER WHEELSTOP (TYPICAL OF 19). SEE DETAIL ON SHEET
- 16. PROPOSED LOCATION OF RELOCATED SIGN.

LANDSCAPE/IRRIGATION NOTES ON SHEET GN-2.

CONSTRUCTION KEYNOTES (#)

- 17. PROPOSED BOLLARD FOR CHARGE POST PROTECTION. SEE DETAIL ON
- 18. CONTRACTOR SHALL REMOVE EXISTING RAILING AND SHALL INSTALL PROPOSED HANDRAIL MOUNTED TO EXISTING PARAPET WALL. RAILING SHALL BE RATED FOR OSHA FALL PROTECTION, INSTALLED 42" TALL WITH 21" HEIGHT OF MIDRAIL WITH OPTIONAL KICKPLATE. OWNER TO PROVIDE FINAL APPROVAL OF RAILING TYPE AND OPTIONS.






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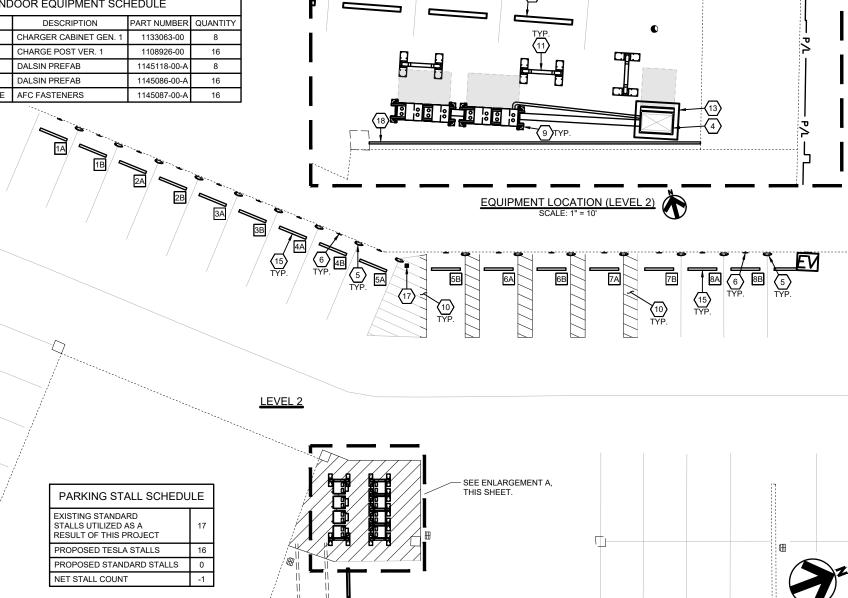
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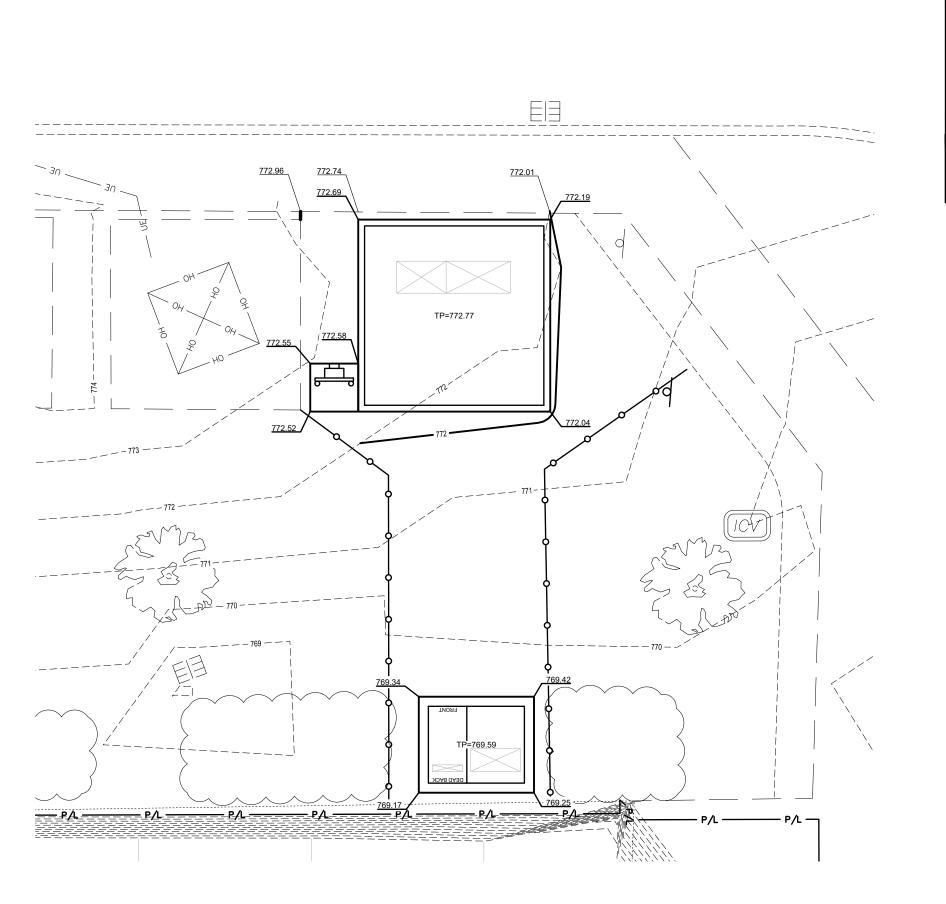
SITE PLAN - LEVEL 2

SHEET NUMBER

C-3

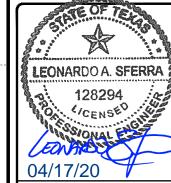SCALE: 1"=20'





GRADING PLAN

GRADING LEGEND

000.00 EX. EXISTING ELEVATION

000.00 PROPOSED ELEVATION AT FINISHED GROUND ELEVATION

T=000.00

PROPOSED TOP OF CURB ELEVATION
PROPOSED BOTTOM OF CURB/FINISHED PAVEMENT ELEVATION B=000.00

TP=000.00 PROPOSED TOP OF PAD ELEVATION

000.00±* MATCH EXISTING ELEVATION

0.0% PROPOSED DRAINAGE SLOPE AND DIRECTION -~~

BENCHMARK

SEE CLARK SURVEY FOR ALL APPLICABLE BENCHMARKS.





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RP/EPM

INSTALLATION MANAGER: ROBERT CORDOVA

CHECKED BY:

REV DATE

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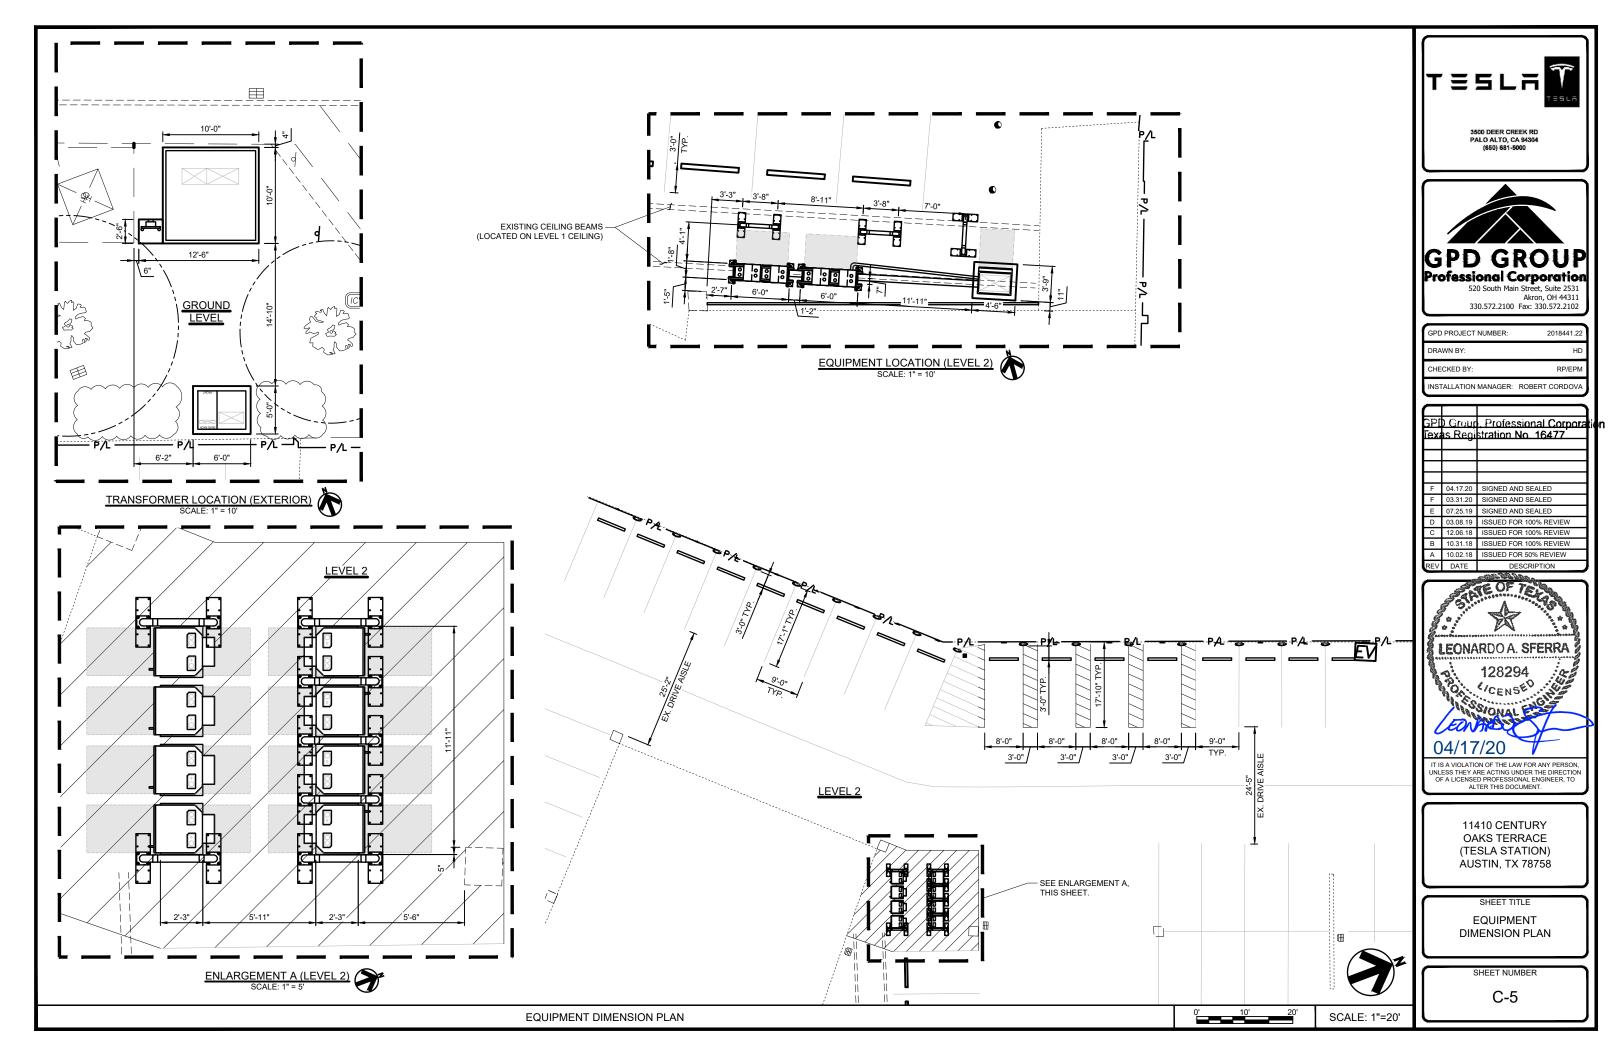
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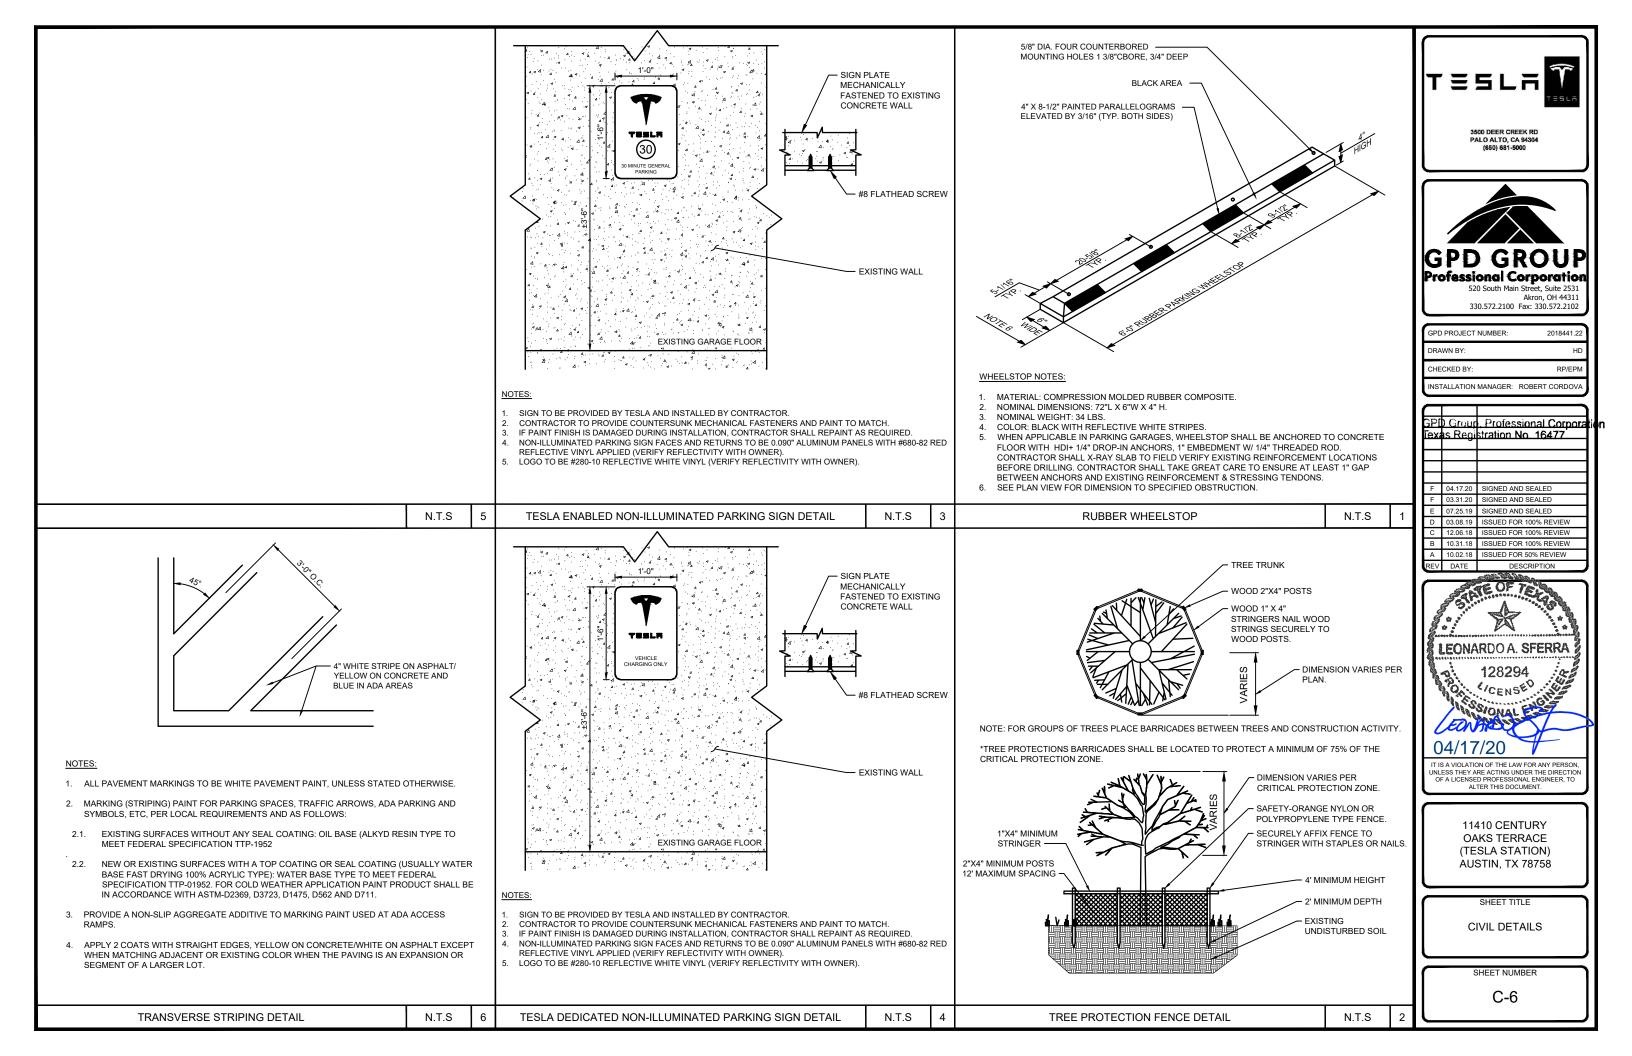
GRADING PLAN


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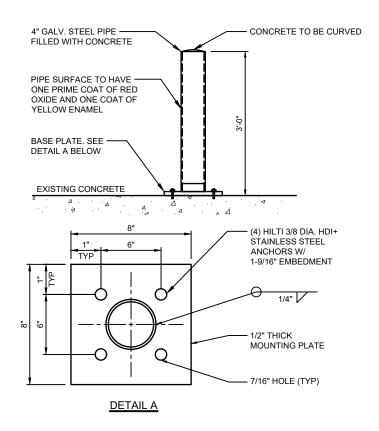
C-4

SCALE: 1"=5'








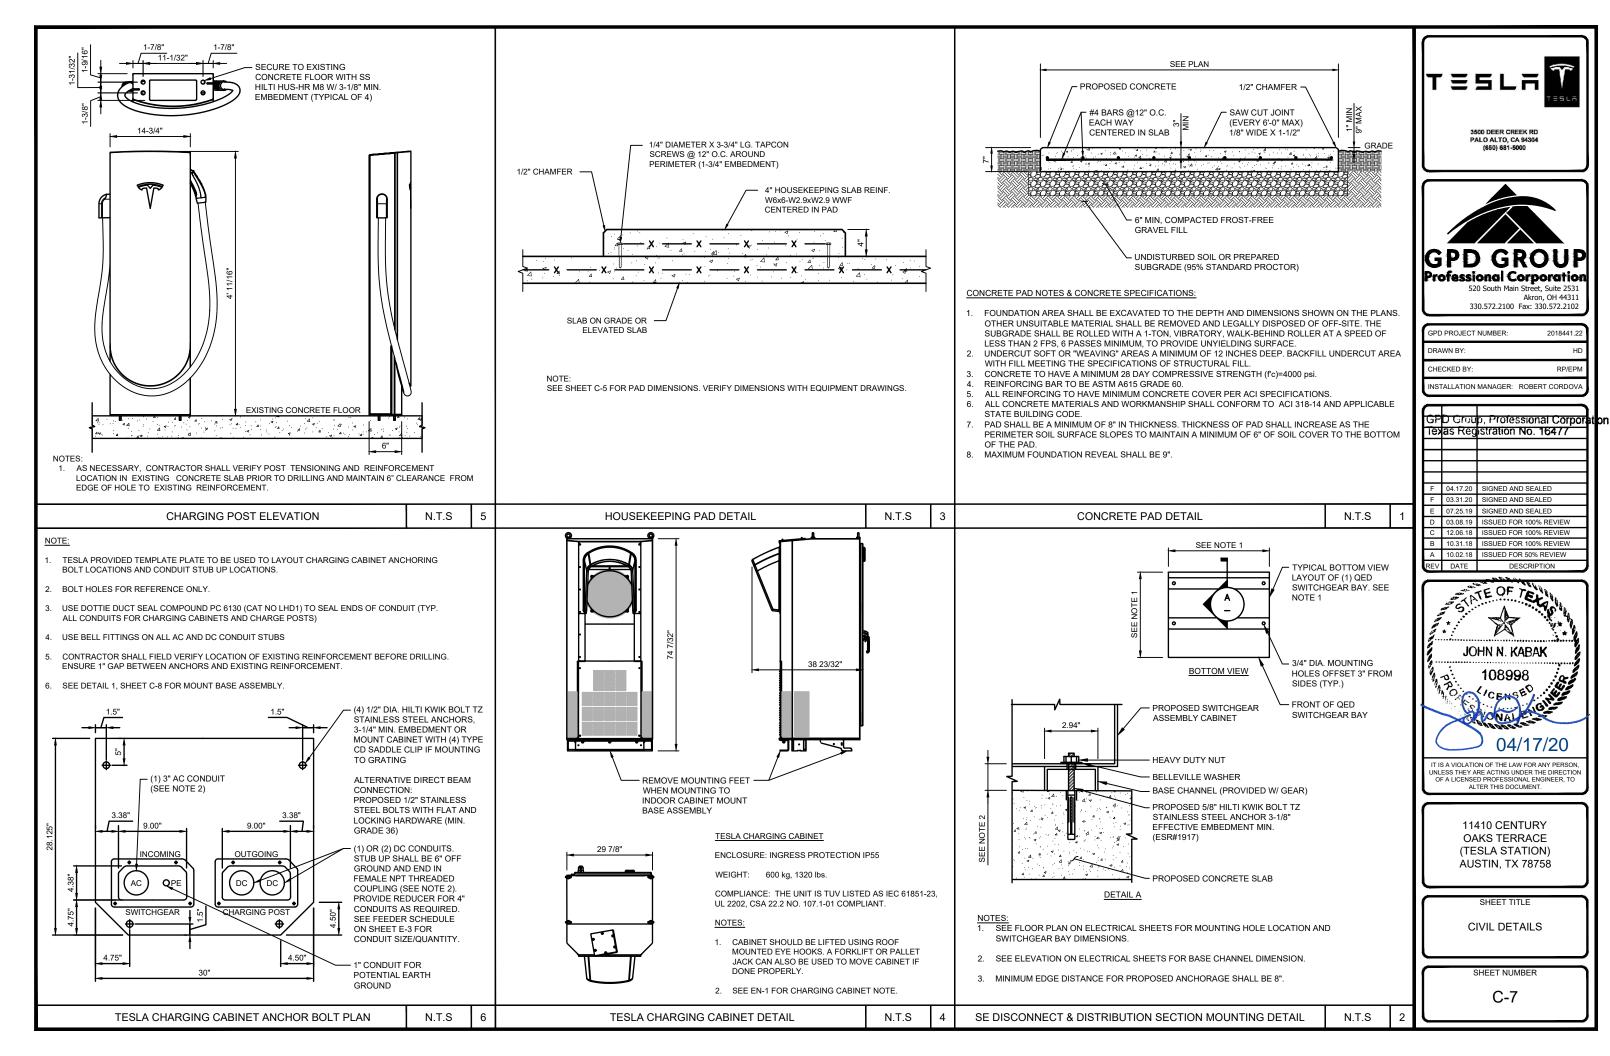

NOTES:

CONTRACTOR SHALL X-RAY CONCRETE SLAB TO FIELD VERIFY EXISTING REINFORCEMENT LOCATIONS BEFORE DRILLING. CONTRACTOR SHALL TAKE GREAT CARE TO ENSURE AT LEAST 3" GAP BETWEEN ANCHORS AND EXISTING REINFORCEMENT AND STRESSING TENDONS.

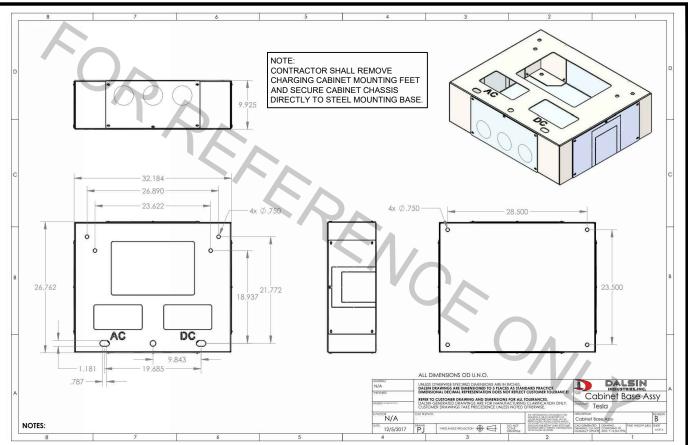

- CHARGING CABINET STEEL MOUNTING BASE IS DESIGNED AND ENGINEERED BY DALSIN INDUSTRIES, INC. INTERIOR EDGES OF CHARGING POST STEEL MOUNTING BASE AND ASSOCIATED HARDWARE SHALL BE COVERED TO PROTECT CABLES FROM DAMAGE.
- 2. CHARGING CABINET STEEL MOUNTING BASE IS PROVIDED BY TESLA AND INSTALLED BY CONTRACTOR.
- 3. GROUND/BOND CHARGING CABINET STEEL MOUNTING BASE PER NEC REQUIREMENTS.
- 4. CONTRACTOR SHALL PROVIDE WEATHERTIGHT CONNECTIONS BETWEEN CHARGING CABINET STEEL MOUNTING BASES & WIREWAY JUNCTIONS.
- 5. BOTTOM STEEL PLATE PROVIDED WITH BASE. GROUND/BOND PER NEC REQUIREMENTS.
- CONTRACTOR SHALL REMOVE CHARGING CABINET MOUNTING FEET AND SECURE CABINET CHASSIS DIRECTLY TO STEEL MOUNTING BASE.
- CHARGING CABINET STEEL MOUNTING BASE SHALL BE SECURED TO CONCRETE FLOOR W/ 1/2" DIA. HILTI HDI+ STAINLESS STEEL DROP-IN ANCHORS, EMBEDMENT 2" (TYPICAL OF 4 ANCHORS PER BASE)

PARKING GARAGE BOLLARD DETAIL N.T.S CHARGING CABINET MOUNT BASE ASSEMBLY DETAIL N.T.S






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SHEET TITLE

CIVIL DETAILS


SHEET NUMBER

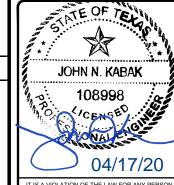N.T.S

C-8

OAKS TERRACE (TESLA STATION) AUSTIN, TX 78758

DETAIL NOT USED

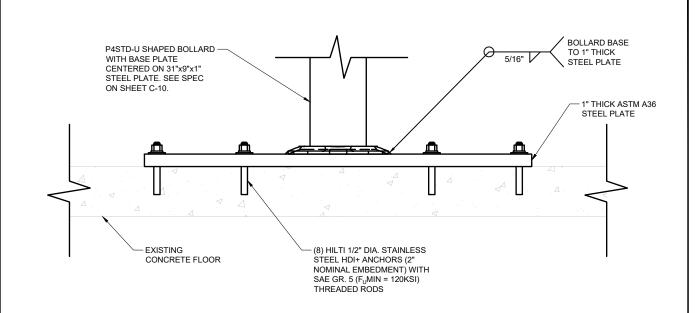



NOTES:

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U-BOLLARD BASE PLATE DETAIL

2. BASE PLATE SHALL BE PAINTED WITH A YELLOW POWDER COAT FINISH.



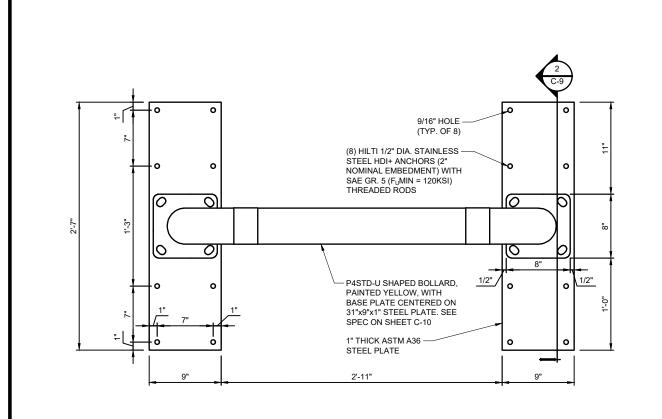

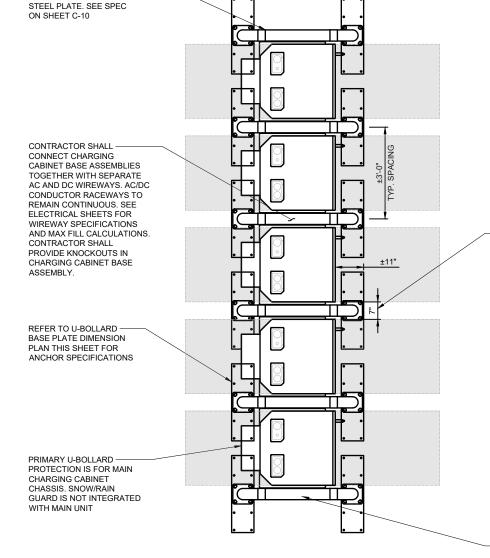WHERE CONDUIT RISER IS PROPOSED, CONTRACTOR SHALL ADJUST END BOLLARD PLACEMENT AS NECESSARY TO PROVIDE REQUIRED CLEARANCE FOR CONDUIT RISER INSTALLATION. SEE ELECTRICAL SHEETS FOR CONDUIT SPECIFICATIONS.

N.T.S

APPROXIMATE DISTANCE BETWEEN

CABINETS. CONTRACTOR SHALL

VERIFY CHARGING CABINET DOOR

CAN SWING 90 DEGREES MINIMUM AND NOTIFY ENGINEER OF ANY

NOTES:

P4STD-U SHAPED BOLLARD -WITH BASE PLATE CENTERED ON 31"x9"x1"

1. REFER TO PLAN VIEWS FOR EXACT BOLLARD AND CHARGING CABINET PLACEMENT



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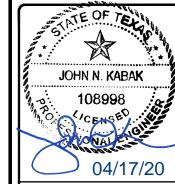
GPD PROJECT NUMBER: 2018441.22
DRAWN BY: HD

RP/EPM

INSTALLATION MANAGER: ROBERT CORDOVA

CHECKED BY:

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CIVIL DETAILS


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C-9

U-BOLLARD BASE PLATE DIMENSION PLAN N.T.S 3 TYPICAL U-BOLLARD & CHARGING CABINET PLACEMENT DETAIL

N.T.S

2

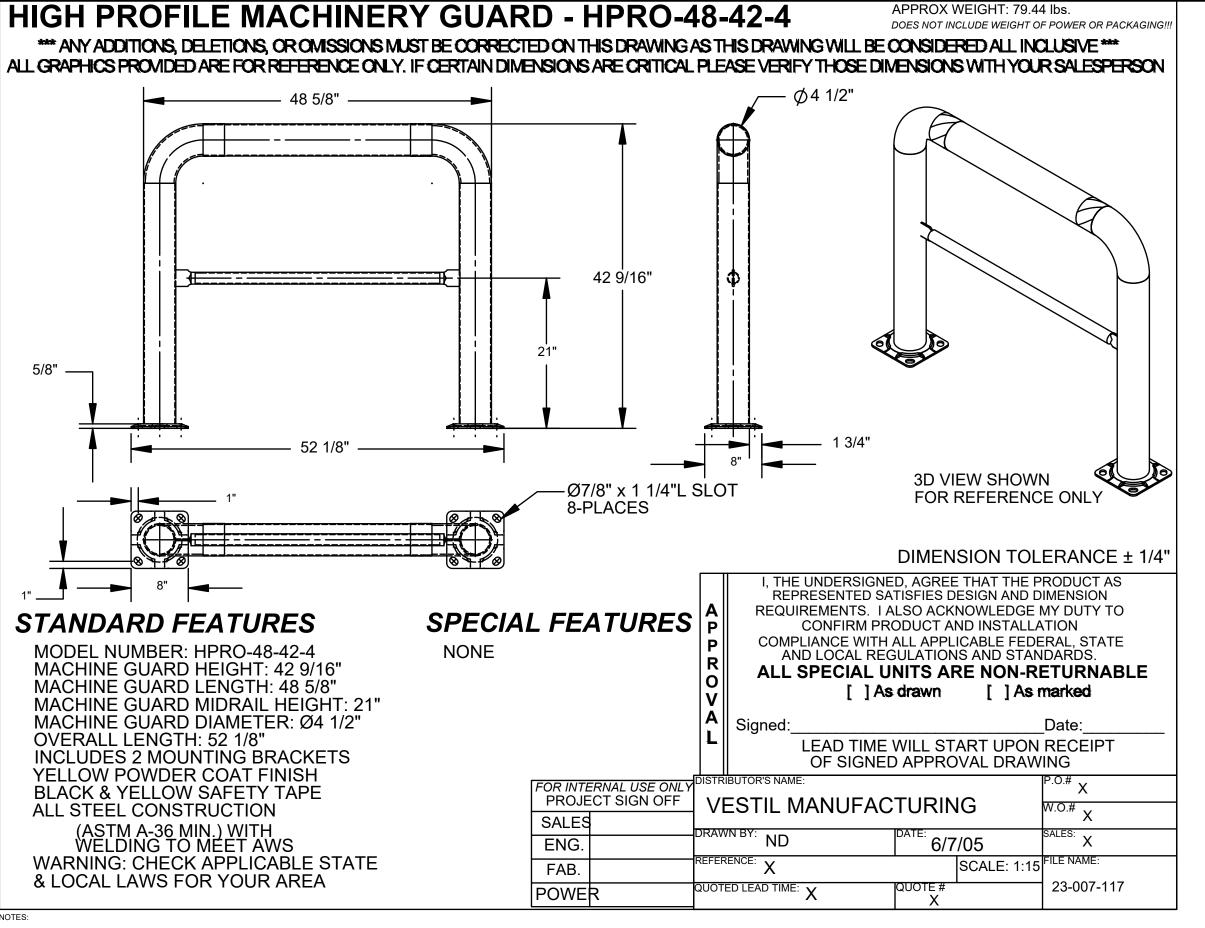

- 1. DETAIL SHOWN ABOVE IS FOR REFERENCE ONLY AND IS DESIGNED & ENGINEERED BY VESTIL MANUFACTURING
- 2. CONTRACTOR SHALL PROVIDE AND INSTALL ABOVE REFERENCED U-BOLLARD BY VESTIL MANUFACTURING OR APPROVED EQUIVALENT

CHECKED BY RP/EPI INSTALLATION MANAGER: ROBERT CORDON

2018441.23

GPD PROJECT NUMBER


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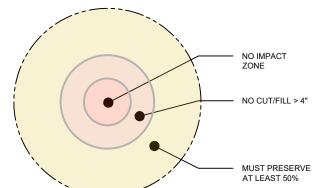
11410 CENTURY OAKS TERRACE (TESLA STATION) AUSTIN, TX 78758

SHEET TITLE

CIVIL DETAILS


C-10



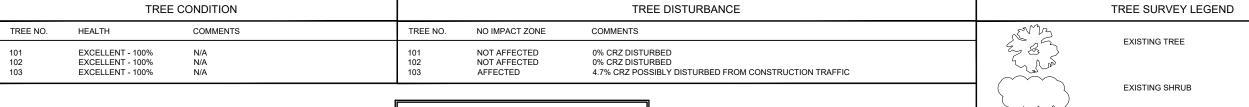

TREE IMPACT CIRCLES

TREE REMOVAL NOTE: NO EXISTING TREES ARE TO BE REMOVED.

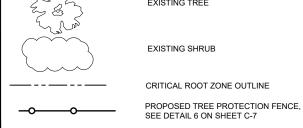

GENERAL NOTE:

TREE CONDITIONS AND SURVEY HAS BEEN COMPLETED B

AN ISA-CERTIFIED ARBORIST.

3500 DEER CREEK RD PALO ALTO, CA 94304 (650) 681-5000

Professional Corporation 520 South Main Street, Suite 2531 Akron, OH 44311

330.572.2100 Fax: 330.572.2102

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TREE SURVEY AND ANALYSIS

SHEET NUMBER


L-1

TREE NO. 102 BALD CYPRESS 11.5" DBH TREE NO. 103 BALD CYPRESS 9.5" DBH	
TREE NO. 101 BALD CYPRESS 8.5" DBH	



SCALE: 1"=10'

TREE SURVEY AND ANALYSIS 5

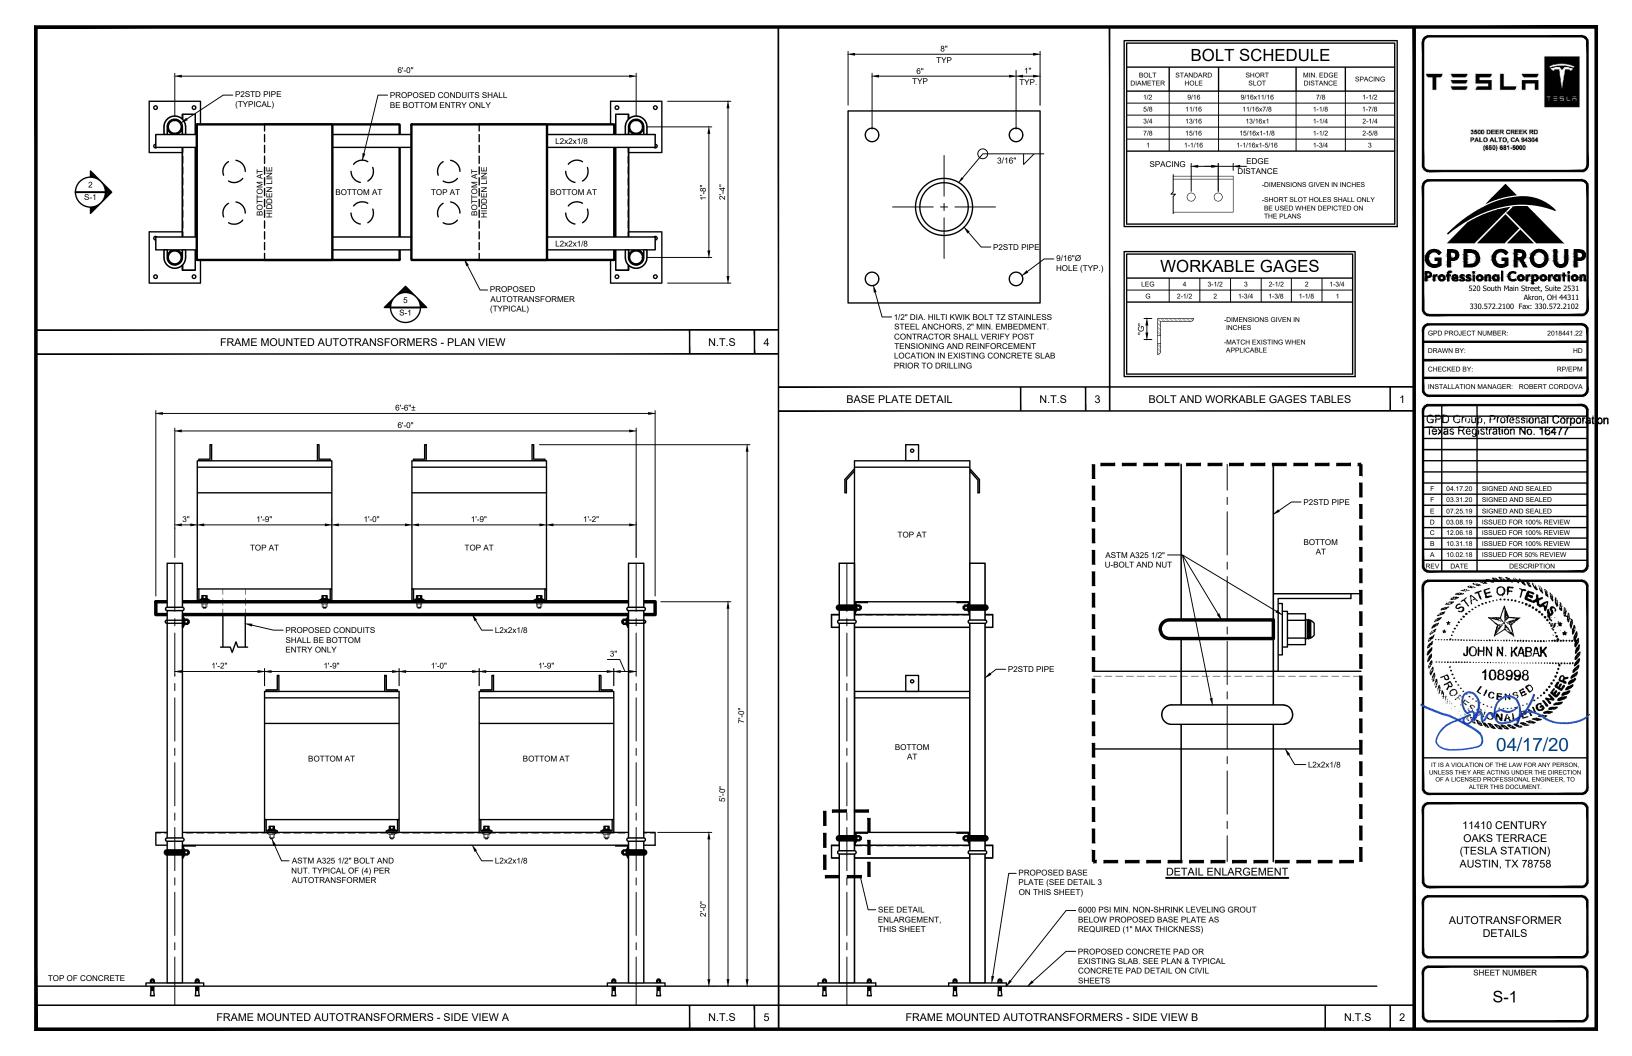

GENERAL ELECTRICAL SPECIFICATIONS

- THE FOLLOWING ARE ABBREVIATED SPECIFICATIONS, ALL ITEMS NECESSARY FOR A COMPLETE AND OPERABLE JOB (TO THE SATISFACTION OF OWNER) WHETHER SHOWN OR IMPLIED SHALL BE HELD AS THE RESPONSIBILITY OF THE CONTRACTOR
- IMPORTANT NOTE: "CONTRACTOR" REFERENCED IN THESE SPECIFICATIONS SHALL INDICATE WORK BY ELECTRICAL CONTRACTOR OR ANY OF HIS SUBCONTRACTORS UNLESS NOTED OTHERWISE
- DRAWINGS ARE DIAGRAMMATIC AND INDICATE GENERAL ARRANGEMENT ONLY. COORDINATE INSTALLATION WITH OTHER TRADES TO VERIEY THE ACTUAL SPACE CONDITIONS THAT ARE TO BE MAINTAINED. NO ADDITIONAL PAYMENT WILL BE APPROVED FOR FAILURE TO COMPLY
- ALL SYMBOLS AND ABBREVIATIONS USED ON THE DRAWINGS ARE CONSIDERED CONSTRUCTION STANDARDS. IF THE CONTRACTOR HAS QUESTIONS REGARDING THEIR EXACT MEANING, THE ENGINEER SHALL BE NOTIFIED FOR CLARIFICATION BEFORE PROCEEDING WITH THE WORK
- CONTRACTOR SHALL NOTE SCALE ELECTRICAL DRAWINGS. REFER TO SITE PLANS AND ELEVATIONS FOR EXACT LOCATIONS OF ALL EQUIPMENT AND CONFIRM WITH CONSTRUCTION MANAGER ANY SIZES AND LOCATIONS WHEN NEEDED
- CONTRACTOR'S SCOPE OF WORK SHALL INCLUDE ALL ITEMS DEFINED IN THE CONTRACT DOCUMENTS. THE CONTRACT DOCUMENTS INCLUDE, BUT ARE NOT LIMITED TO THE FOLLOWING: THE CONTRACT, SPECIFICATIONS, AND CONSTRUCTION DRAWINGS. CONTRACTOR SHALL PROVIDE ALL LABOR, MATERIAL, AND EQUIPMENT NECESSARY TO INSTALL ALL ELECTRICAL EQUIPMENT. CONDUIT. WIRING ETC. AS SHOWN OR IMPLIED ON THE DRAWINGS AND TO PROVIDE A COMPLETE OPERATIVE SYSTEM TO THE SATISFACTION OF OWNER
- CONTRACTOR SHALL PROVIDE ON-SITE SUPERVISION AT ALL TIMES WHILE THE WORK IS BEING PERFORMED AND SHALL DIRECT ALL WORK, USING HIS BEST SKILL AND ATTENTION. HE SHALL BE SOLELY RESPONSIBLE FOR ALL CONSTRUCTION MEANS, METHODS, TECHNIQUES, PROCEDURES AND SEQUENCES FOR COORDINATING ALL PORTIONS OF THE WORK LINDER THE CONTRACT
- INSTALLATION OF ALL ELECTRICAL EQUIPMENT, DEVICES, CONDUITS, ETC. MUST BE COORDINATED WITH ALL OTHER TRADES. COORDINATE SHUTDOWN TIMES AND WORKING HOURS WITH BUILDING OWNER, INCLUDING OFF HOURS, WEEKEND, AND HOLIDAY WORK AS REQUIRED
- ANY DISCREPANCIES FOUND WITHIN THE CONTRACT DOCUMENTS SHALL BE REPORTED TO THE OWNER IN WRITING PRIOR TO THE AWARD OF THE CONTRACT AND AN ADDENDUM WILL BE ISSUED
- GUARANTEE CONTRACTOR SHALL FURNISH OWNER WITH A WRITTEN GUARANTEE TO PROMPTLY REMEDY ALL DEFECTS OF WORK OR MATERIALS WITHOUT CHARGE FOR A PERIOD OF ONE YEAR AFTER FINAL ACCEPTANCE AND INSPECTION
- MATERIALS ALL MATERIALS AND EQUIPMENT SHALL BE NEW, IN ORIGINAL CONTAINERS/WRAPPINGS SHALL BE SPECIFICATION GRADE, AND LABELED OR LISTED BY U.L. OR AN ACCREDITED TESTING ORGANIZATION AS REQUIRED BY LOCAL INSPECTORS
- CONTRACTOR SHALL PROVIDE ADEQUATE AND REQUIRED LIABILITY INSURANCE FOR PROTECTION AGAINST PUBLIC LOSS AND ANY/ALL PROPERTY DAMAGE FOR THE DURATION OF WORK
- ALL EQUIPMENT SHALL BE DESIGNED TO OPERATE ON VOLTAGE AND PHASE SPECIFIED. CONTRACTOR FURNISHING EQUIPMENT OTHER THAN INDICATED SHALL BE RESPONSIBLE FOR ANY CHANGES IN CONDUCTORS, RACEWAYS, SWITCHES, MAIN FEEDERS, AND APPURTENANCES AND PAY ALL ASSOCIATED COSTS. REQUIREMENTS FOR ANY INCREASE IN CAPACITIES SHALL BE REVIEWED
- CONTRACTOR SHALL CONFIRM WITH LOCAL UTILITY COMPANY ANY/ALL REQUIREMENTS SUCH AS THE: LUG SIZE RESTRICTIONS, CONDUIT ENTRY, SIZE OF TRANSFORMERS, SCHEDULED DOWNTIME FOR THE OWNERS' CONFIRMATION, ETC. ANY/ALL CONFLICTS SHALL BE BROUGHT TO THE ATTENTION OF THE CONSTRUCTION MANAGER, PRIOR TO BEGINNING ANY WORK

LICENSES, CERTIFICATIONS OF INSPECTION

- CONTRACTOR SHALL BE RESPONSIBLE FOR NOTIFICATION OF ALL GOVERNING AGENCIES THAT REQUIRE SITE INSPECTION OF THE WORK AND/OR SIMPLY NOTIFICATION. THE CONTRACTOR SHALL OBTAIN AND PAY FOR PERMITS, LICENSES AND INSPECTIONS NECESSARY FOR PERFORMANCE OF
- CONTRACTOR AND ALL OF HIS SUBCONTRACTORS THAT PERFORM ANY WORK ON THIS PROJECT SHALL BE CURRENTLY LICENSED BY ALL AGENCIES WHICH GOVERN OVER THE LAND(S) ON WHICH CONSTRUCTION IS TO TAKE PLACE. CONTRACTOR SHALL SECURE ALL PERMITS AND INSPECTIONS AS REQUIRED, ALL COSTS SHALL BE BORNE BY CONTRACTOR
- THE CONTRACTOR SHALL SECURE AND PAY FOR ALL PERMITS, LICENSES AND INSPECTIONS INCIDENTAL TO WORK UNDER THIS CONTRACT, WHEN THE WORK IS COMPLETED. THE REQUIRED CERTIFICATES OF APPROVAL SHALL BE FURNISHED TO THE BUILDING OWNER. CONTRACTOR MUST BE LICENSED IN THE STATE, COUNTY AND CITY OF THE PROJECT SITE.

CODES AND ORDINANCES

- ALL WORK SHALL BE DONE IN STRICT ACCORDANCE WITH LATEST EDITION OF NEC AND ALL APPLICABLE CODES AND ORDINANCES. INCLUDING SUCH AS PERTAIN TO THE SAFETY AND HEALTH RELATIONS. CODES AND ORDINANCES SHALL TAKE PRECEDENCE OVER THE DRAWINGS AND SPECIFICATIONS ONLY IN CASE OF CONFLICT AND SHALL INCLUDE BUT NOT BE LIMITED TO:
- **UL UNDERWRITERS LABORATORIES**
- NEC NATIONAL ELECTRICAL CODE
- NEMA NATIONAL ELECTRICAL MANUFACTURERS ASSOC.
- OSHA OCCUPATIONAL SAFETY AND HEALTH ACT
- SBC STANDARD BUILDING CODE
- NFPA NATIONAL FIRE CODES

CHARGING CABINET NOTE

PER NEC 625.22 - THE USER INTERFACE (CHARGE POST) IS CONTROLLED BY THE ELECTRICAL EQUIPMENT (CHARGING CABINET) AND THE FOLLOWING PRECAUTIONS HAVE BEEN TAKEN TO ENSURE THE SAFETY OF CUSTOMERS AND THOSE AROUND THE EQUIPMENT. BEFORE ANY VOLTAGE OR CURRENT IS APPLIED TO THE CHARGE POST, THE CABINET MUST COMMUNICATE WITH THE TESLA VEHICLE. THERE IS A 'HANDSHAKE' BETWEEN THE CAR AND THE CABINET CONFIRMING THAT THE VEHICLE IS ACTUALLY A TESLA AND THAT THE VEHICLE CAN HANDLE THE SUPERCHARGING. VOLTAGE IS THEN APPLIED TO THE POWER SOCKETS IN THE CHARGE POST AND ONCE THE VOLTAGE READING FROM THE CAR IS VERIFIED AS THE SAME IN THE CHARGING CABINET, THEN CURRENT BEGINS TO FLOW, IF AT ANY POINT IN THIS PROCESS A FAULT IS DETECTED. THE CHARGING WILL STOP IMMEDIATELY, WITHIN A MATTER OF MILLISECONDS. DURING THE NORMAL CHARGING CYCLE, IF ANY FAULT OR IRREGULARITY IS DETECTED, THE CHARGING WILL AGAIN STOP WITHIN MILLISECONDS OF DETECTION. BEYOND THIS LOGIC PROTECTION, THERE IS PHYSICAL PROTECTION FROM OVER-CURRENT OR OVER-VOLTAGE WITHIN EACH OF THE CHARGERS, BEYOND THAT, EAST ACTING FUSES ALSO PROTECT THE VEHICLE OUTPUTS FROM OUTPUTTING TOO HIGH OF A CURRENT

POST CONSTRUCTION AND PROJECT CLOSEOUT DOCUMENTATION

AS-BUILT REQUIREMENTS: DO NOT USE RECORD DOCUMENTS FOR CONSTRUCTION PURPOSES. TO PROTECT RECORD DOCUMENTS FROM DETERIORATION AND LOSS, STORE IN A SECURE, FIRE-RESISTANT LOCATION PROVIDE ACCESS TO RECORD DOCUMENTS FOR THE OWNER'S REFERENCE DURING NORMAL WORKING HOURS. MAINTAIN A CLEAN, UNDAMAGED SET OF BLUE OR BLACK LINE PRINTS OF CONTRACT DRAWINGS AND SHOP DRAWINGS. MARK THE SET TO SHOW THE ACTUAL INSTALLATION WHERE THE INSTALLATION VARIES SUBSTANTIALLY FROM THE WORK AS ORIGINALLY SHOWN. MARK DRAWINGS THAT ARE MOST CAPABLE OF SHOWING CONDITIONS FULLY AND ACCURATELY. WHERE SHOP DRAWINGS ARE USED, RECORD A CROSS-REFERENCE AT THE CORRESPONDING LOCATION ON THE CONTRACT DRAWINGS. GIVE PARTICULAR ATTENTION TO CONCEALED ELEMENTS THAT WOULD BE DIFFICULT TO MEASURE AND RECORD AT A LATER DATE MARK RECORD SETS WITH RED ERASABLE PENCIL. USE OTHER COLORS TO DISTINGUISH BETWEEN VARIATIONS IN SEPARATE CATEGORIES OF THE WORK. MARK NEW INFORMATION THAT IS IMPORTANT TO THE OWNER BUT WAS NOT SHOWN ON THE CONTRACT DRAWINGS, DETAILS OR SHOP DRAWINGS. NOTE RELATED CHANGE ORDER NUMBERS WHERE APPLICABLE. NOTE RELATED RECORD DRAWING INFORMATION AND PRODUCT DATA. LIPON COMPLETION OF THE WORK, SUBMIT ONE (1) COMPLETE SET OF RECORD DOCUMENTS TO THE CONSTRUCTION MANAGER FOR THE OWNER'S RECORDS. CONTRACTOR SHALL SUBMIT AS-BUILT SET OF PLANS TO THE ENGINEER WITHIN 7 DAYS OF COMPLETION OF CONSTRUCTION.

EXISTING CONDITIONS AND DEMOLITION

- ALL ELECTRICAL DEMOLITION WORK, INCLUDING MATERIAL REMOVAL FROM THE SITE, SHALL BE THE RESPONSIBILITY OF THIS CONTRACTOR. BEFORE PROCEEDING WITH THE DEMOLITION WORK, THE CONTRACTOR SHALL OBTAIN FROM THE BUILDING OWNER A LIST OF ANY REMOVED ITEMS TO BE SALVAGED. ALL OTHER REMOVED MATERIALS AND EQUIPMENT SHALL BE PROPERLY DISCARDED OFF THE PREMISES
- CONTRACTOR SHALL BE RESPONSIBLE FOR ANY DAMAGE TO EXISTING PROPERTY RESULTING FROM THE CONSTRUCTION ACTIVITIES. CONTRACTOR SHALL REMOVE ALL DEBRIS FROM THE SITE AT THE COMPLETION OF WORK
- EXISTING UTILITIES AND CONDITIONS ARE SHOWN FROM FIELD DATA AND EXISTING DOCUMENTS AND ARE NOT NECESSARILY COMPLETE OR ACCURATE. ALL FIELD CONDITIONS SHALL BE VERIFIED BY CONTRACTOR BEFORE START OF CONSTRUCTION
- CONTRACTOR SHALL BE RESPONSIBLE TO LOCATE, EXPOSE, AND DETERMINE IF CONFLICTS EXIST WITH THE PROPOSED IMPROVEMENTS. CONTRACTOR SHALL NOTIFY THE OWNER IN ORDER TO RESOLVE ANY CONFLICTS. EXISTING ELECTRICAL CONDUIT, WIRING, ETC. DAMAGED DURING RENOVATION SHALL BE REPLACED IN LIKE KIND AND CHARACTER, AND AT THE EXISTING UTILITY LINES, DRAIN OR FIELD TILE DAMAGED SHALL BE REPAIRED OR REPLACED, AS NEEDED, IN LIKE KIND AND CHARACTER. IT SHALL BE THE RESPONSIBILITY OF THE CONTRACTOR TO LOCATE ALL EXISTING CONDUITS, CONTROL WIRING, ETC., WHETHER SHOWN HEREON OR NOT, AND TO PROTECT THEM FROM DAMAGE. THE CONTRACTOR SHALL BEAR ALL EXPENSES FOR REPAIR OR REPLACEMENT OF PROPERTY DAMAGED IN CONJUNCTION WITH THE EXECUTION OF WORK
- THE CONTRACTOR SHALL NOTIFY THE OWNER OF ANY CONFLICTS OR DISCREPANCIES IN THE CONTRACT DOCUMENTS OR FIELD CONDITIONS PRIOR TO EXECUTING THE WORK IN QUESTION. THE CONTRACTOR SHALL NOTIFY THE CONSTRUCTION MANAGER IF DETAILS ARE CONSIDERED UNSOUND, UNSAFE, NOT WATERPROOF, OR NOT WITHIN CUSTOMARY TRADE PRACTICE. IF WORK IS PERFORMED IT WILL BE ASSUMED THAT THERE IS NO OBJECTION TO THE DETAIL DETAIL S ARE INTENDED TO SHOW THE END RESULT OF THE DESIGN. MINOR MODIFICATIONS MAY BE REQUIRED TO SUIT JOB CONDITIONS, AND SHALL BE INCLUDED AS PART OF THE WORK.
- SITE VISIT CONTRACTOR SHALL VISIT THE SITE AND FAMILIARIZE THEMSELVES WITH ALL CONDITIONS AFFECTING HIS WORK. NO EXTRAS WILL BE PERMITTED FOR LACK OF KNOWLEDGE OF EXISTING CONDITIONS. QUANTITIES OF MATERIALS SHALL BE PER CONTRACTOR'S MEASUREMENTS

BASIC ELECTRICAL MATERIALS AND METHODS

- WHERE STRUCTURAL OPENINGS ARE NOT AVAILABLE. THE CONTRACTOR SHALL CORE DRILL OR CUT CHASES IN WALLS AND FLOORS AS REQUIRED. ALL NEW OPENINGS SHALL BE COORDINATED WITH THE ENGINEER. ALL PENETRATIONS OF THE BUILDING WALLS, CEILING AND FLOORS, THE CONTRACTOR SHALL SEAL WITH QUALITY CAULK, FIRE RATED AND WATERTIGHT, SUBMITTED FOR APPROVAL BY THE OWNER
- TRASH REMOVAL: CONTRACTOR SHALL REMOVE ALL TRASH CREATED BY THEMSELVES OR HIS SUBCONTRACTORS DUE TO DEMOLITION OR CONSTRUCTION. THE CONTRACTOR SHALL ALSO REMOVE TRASH CREATED BY OTHER SUBCONTRACTORS INCLUDING CABLE REELS. CARDBOARD BOXES AND PACKING. PROMPTLY CLEAN-UP ALL SOILING, DEBRIS AND OTHER UNSIGHTLY OR HAZARDOUS CONDITIONS, CAUSED BY WORK OR DELIVERIES UNDER THIS CONTRACT, FROM THE BUILDING GROUNDS, ENTRIES, CORRIDORS, STAIRWAYS, ELEVATORS OR OTHER PUBLIC AREAS. ALL SHALL BE REMOVED FROM THE SITE IN A TIMELY FASHION TO A LEGAL DISPOSAL FACILITY
- SIGNAGE: CONTRACTOR SHALL MAINTAIN SECURITY AROUND PERIMETER OF CONSTRUCTION SITE DURING ALL HOURS BY INSTALLING A TEMPORARY RIBBON FOR INTERIOR WORK TO IDENTIFY CONSTRUCTION AREAS AS REQUIRED. SIGNAGE SHALL BE POSTED WITH NOTIFICATIONS OF "NO RESPASSING" AND "CONSTRUCTION AREA"
- CHECK ACCURACY OF ALL DIMENSIONS IN THE FIELD. UNLESS SPECIFICALLY NOTED, DO NOT FABRICATE ANY MATERIALS OFF SITE. NOR DO ANY CONSTRUCTION UNTIL THE ACCURACY OF 4. DRAWING DIMENSIONS HAVE BEEN VERIFIED AGAINST ACTUAL FIELD DIMENSIONS
- CONTRACTOR SHALL BE RESPONSIBLE FOR ALL NECESSARY CLITTING, SUBSPOLIENT PATCHING, AND REQUIRED ELASHING FOR ALL ITEMS NECESSARY FOR ELECTRICAL PART OF THE CONTRACT. PATCH PAINT, AND REPAIR ANY AREA DAMAGED TO THE SATISFACTION OF THE BUILDING OWNER.
- THE EXACT LOCATIONS OF ALL ELECTRICAL DEVICES, EQUIPMENT AND CONDUIT, AS SHOWN ON THE DRAWING, IS APPROXIMATE. WHEN NOT SHOWN IN DETAIL, THE EXACT LOCATION OR ROUTING SHALL BE DETERMINED BY THE CONTRACTOR SUBJECT TO THE APPROVAL OF OWNER
- THE CONTRACTOR SHALL PROVIDE ALL NECESSARY BLOCKING, BACKING, FRAMING, HANGERS OR OTHER SUPPORT FOR THE MOUNTING AND SUPPORT OF ALL ITEMS REQUIRING THE SAME AS
- TRENCHING AND BACK FILL: CONTRACTOR SHALL PROVIDE FOR ALL UNDERGROUND INSTALLED CONDUIT AND/OR CABLES INCLUDING EXCAVATION AND BACKELLING AND COMPACTION
- WHEN DIRECTIONAL BORING IS REQUIRED, CONTRACTOR SHALL INSTALL A LOOSE TONING WIRE WITHIN INSTALLED CONDUIT TO ALLOW FOR IDENTIFICATION OF UNDERGROUND CONDUITS
- ALL BOLTS SHALL BE STAINLESS STEEL.
- FOR UNDERGROUND RACEWAYS, PROVIDE ADDITIONAL SLACK IN CONDUCTORS AND CONDUIT EXPANSION JOINTS IN ORDER TO ALLOW FOR EARTH MOVEMENT FROM SETTLEMENT, FROST, ETC. IN ORDER TO PREVENT DAMAGE TO THE CONDUCTORS OR TO THE EQUIPMENT CONNECTED TO THE



3500 DEER CREEK RD PALO ALTO, CA 94304



Akron, OH 44311 330.572.2100 Fax: 330.572.2102

GPD PROJECT NUMBER 2018441.22 RAWN RY

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RP/EPM INSTALLATION MANAGER: ROBERT CORDOV

GPD Groun, Professional Corporat Texas Registration No. 16477 F 04.17.20 SIGNED AND SEALED SIGNED AND SEALED 03.31.20 E 07.25.19 SIGNED AND SEALED D 03.08.19 ISSUED FOR 100% REVIEW C 12.06.18 ISSUED FOR 100% REVIEW B 10.31.18 ISSUED FOR 100% REVIEW A 10.02.18 ISSUED FOR 50% REVIEW REV DATE DESCRIPTION



T IS A VIOLATION OF THE LAW FOR ANY PERSON NLESS THEY ARE ACTING UNDER THE DIRECTIO OF A LICENSED PROFESSIONAL ENGINEER, TO ALTER THIS DOCUMENT.

> 11410 CENTURY OAKS TERRACE (TESLA STATION) AUSTIN, TX 78758

> > SHEET TITLE

ELECTRICAL **GENERAL NOTES**

SHEET NUMBER

EN-1

ELECTRICAL EQUIPMENT

ALL EQUIPMENT SHALL BE DESIGNED TO OPERATE ON VOLTAGE AND PHASE SPECIFIED.
CONTRACTOR FURNISHING EQUIPMENT OTHER THAN INDICATED SHALL BE RESPONSIBLE FOR ANY
CHANGES IN CONDUCTORS, RACEWAYS, SWITCHES, MAIN FEEDERS, AND APPURTENANCES AND
PAY ALL ASSOCIATED COSTS. REQUIREMENTS FOR ANY INCREASE IN CAPACITIES SHALL BE
REVIEWED BY ENGINEER

FIRESTOPPING AND SEALING ELECTRICAL PENETRATIONS

- CONTRACTOR SHALL FURNISH AND INSTALL FIRESTOPPING FOR SEALING AROUND ELECTRICAL PENETRATIONS THROUGH FIRE OR SMOKE BARRIERS, AND FLOORS.
- 2. PROVIDE SHOP DRAWINGS OF EACH CONDITION REQUIRING PENETRATION SEALS AND THE PROPOSED UL SYSTEMS MATERIALS, ANCHORAGE, METHODS OF INSTALLATION, AND ACTUAL ADJACENT CONSTRUCTION. SUBMITTAL PACKAGE SHALL ALSO INCLUDE A COPY OF THE UL ILLUSTRATION OF EACH PROPOSED SYSTEM INDICATING MANUFACTURER APPROVED MODIFICATIONS (IF APPLICABLE) AND THE MANUFACTURER'S SPECIFICATIONS, RECOMMENDATIONS, INSTALLATION INSTRUCTIONS, AND MAINTENANCE INSTRUCTIONS.
- 3. FIRESTOPPING MATERIALS SHALL BE INTUMESCENT SAFETY BARRIERS DESIGNED TO BLOCK THE SPREAD OF FIRE AND SMOKE THROUGH PENETRATIONS CREATED BY ELECTRICAL INSTALLATIONS IN FIRE RATED WALLS AND FLOORS. MATERIALS SHALL BE FLAME, TOXIC FUME, AND WATER RESISTANT AND SHALL HAVE A MINIMUM 3 HOUR FIRE RATING. FIRE RATING SHALL BE DEFINED BY TESTS CONDUCTED BY ASTM, UL OR OTHER TESTING AND INSPECTION AGENCIES ACCEPTABLE TO AUTHORITIES HAVING JURISDICTION.
- PROVIDE MATERIALS BY THE FOLLOWING MANUFACTURERS TO SUIT THE APPLICATION: SPECIFIED TECHNOLOGIES, INC (STI), SOMERVILLE, NJ; TREMCO, INC., BEACHWOOD, OH; OR 3M INC., MINISTRADOL IS MIN.

FAULT CURRENT, COORDINATION STUDY, AND ARC FLASH

- . CONTRACTOR SHALL CONDUCT A FAULT CURRENT CALCULATION AND COORDINATION STUDY TO ENSURE THE CORRECT AIC RATING OF NEW ELECTRICAL PANELBOARDS AND THE SETTINGS OF ANY ADJUSTABLE BREAKERS. THE RESULTS OF THESE STUDIES SHALL BE SUBMITTED WITH THE PANELBOARD SHOP DRAWINGS. ANY PANELS SUBMITTED WITHOUT THIS DOCUMENTATION WILL BE REJECTED WITHOUT BEING REVIEWED AT THE CONTRACTOR'S EXPENSE.
- 2. CONTRACTOR SHALL PROVIDE AN ARC-FLASH STUDY AND LABEL ALL EQUIPMENT AS REQUIRED PER THE N.E.C.

GROUNDING AND BONDING FOR ELECTRICAL SYSTEMS

- ALL RACEWAYS AND EQUIPMENT SHALL BE GROUNDED IN ACCORDANCE WITH THE N.E.C. AND ANY LOCAL CODES.
- 2. ALL CONDUITS SHALL CONTAIN A CODE SIZE GROUNDING CONDUCTOR
- 3. EQUIPMENT GROUNDING CONDUCTORS SHALL BE INSULATED WITH GREEN-COLORED INSULATION
- 4. GROUNDING ELECTRODE CONDUCTORS SHALL BE STRANDED CABLE.
- MATERIALS AND CONNECTION COMPONENTS FOR GROUNDING AND BONDING SHALL BE MANUFACTURED BY ERICO. THOMAS & BETTS, OR BURNDY.

ELECTRICAL IDENTIFICATION

- PROVIDE NAMEPLATES FOR ALL MAJOR ELECTRICAL EQUIPMENT AND ON EQUIPMENT AS DIRECTED BY OWNER.
- PROVIDE ALL FEEDERS AND BRANCH CIRCUIT WIRING WITH COLOR CODED VINYL TAPE WRAPPED A MINIMUM OF 1.5 TIMES AROUND CIRCUMFERENCE OF JACKET/SHIELDING TO DESIGNATE PHASE.
- 3. COLOR CODING OF CONDUCTORS SHALL BE PER OWNERS REQUIREMENTS.
- 4. CONTRACTOR SHALL PLACE TWO LENGTHS OF WARNING TAPE AT A DEPTH OF 12" BELOW GROUND AND DIRECTLY ABOVE ELECTRICAL SERVICE CONDUITS. CAUTIONS TAPE TO READ "CAUTION BURJED ELECTRIC"

CONDUCTORS AND CABLES

- WIRING ALL CONDUCTORS SHALL BE EQUAL TO OR BETTER THAN MINIMUM #12 AWG FOR POWER, #14 AWG FOR CONTROL WITH 98% CONDUCTIVITY STRANDED COPPER, 600V, COLOR CODED, UNLESS NOTED ALUMINUM (AL). REFER TO "ALUMINUM CONDUCTOR REQUIREMENTS" THIS SHEET. PROVIDE 75°C RATED CONDUCTORS FOR AMPACITIES ABOVE 100A AND 60°C RATED CONDUCTORS FOR AMPACITIES OF 100 AMPS OR LESS. PROVIDE SOLID OR STRANDED FOR #10 AWG AND SMALLER, STRANDED FOR #8 AWG AND LARGER. UNLESS NOTED OTHERWISE ON DRAWINGS.
- WIRE SIZE OF BRANCH CIRCUITS SHALL BE ADJUSTED TO COMPENSATE FOR VOLTAGE DROP BASED UPON ACTUAL CONDUIT ROUTING. CONTRACTOR SHALL MAINTAIN VOLTAGE DROP AS RECOMMENDED BY N.E.C. (NOT TO EXCEED 3%).
- 3. PROVIDE A SEPARATE NEUTRAL FOR EACH BRANCH CIRCUIT, FEEDER, ETC. NEUTRALS ARE NOT PERMITTED TO BE SHARED.
- CONNECTORS FOR POWER CONDUCTORS: CONTRACTOR SHALL USE PRESSURE TYPE INSULATED TWIST-ON CONNECTORS FOR NO. 10 AWG AND SMALLER. USE SOLDERLESS MECHANICAL TERMINAL LUGS FOR NO. 8 AWG AND LARGER.
- ALL CONNECTIONS SHALL BE MADE WITH A PROTECTIVE COATING OF AN ANTI-OXIDE COMPOUND SUCH AS "NO-OXIDE A" BY DEARBORNE CHEMICAL CO. COAT ALL WIRE SURFACES BEFORE CONNECTING. EXPOSED COPPER SURFACES, INCLUDING GROUND BARS, SHALL BE TREATED - NO SUBSTITUTIONS.
- CABLES MC CABLE IS NOT PERMITTED.
- 7. PROVIDE WIRE AND CABLE MANUFACTURED BY ONE OF THE FOLLOWING: AMERICAN INSULATED WIRE CORPORATION; NEXANS; CERROWIRE; SOUTHWIRE; OR ENCORE WIRE.
- PROVIDE CONNECTORS MANUFACTURED BY ONE OF THE FOLLOWING: AMP INCORPORATED; GENERAL SIGNAL, O-Z/GEDNEY UNIT; SQUARE D COMPANY, ANDERSON; ILSCO; OR BURNDY.

ALUMINUM CONDUCTOR REQUIREMENTS

- ALUMINUM CONDUCTOR GRADE SHALL BE MINIMUM AA-8000 OR THE NEWEST ALUMINUM CONDUCTOR SPECIFICATION BEING USED BY THE INDUSTRY.
- THE CONTRACTOR SHALL ABIDE BY ALL ARTICLES RELATED TO ALUMINUM CONDUCTORS IN THE LATEST ISSUE OF THE NEC.
- ALUMINUM CONDUCTORS SHALL ONLY BE TERMINATED USING ALUMINUM RATED CONNECTIONS.
 CONTRACTOR SHALL VERIFY TERMINATIONS ON EACH DEVICE OR EQUIPMENT BEFORE START OF
 WORK FOR RATED ALUMINUM CONNECTORS.
- 4. THE CONTRACTOR SHALL ABIDE BY ALL ALUMINUM WIRING INSTALLATION STANDARDS AS REQUIRED BY THE NEIS (NATIONAL ELECTRICAL INSTALLATION STANDARDS) PUBLISHED BY THE NECA (NATIONAL ELECTRICAL CONTRACTORS ASSOCIATION). THE CONTRACTOR SHALL ABIDE BY ALL STANDARDS IN THE NECA / AA - 2006, WHICH DEFINES MINIMUM STANDARDS OF QUALITY AND WORKMANSHIP. A SUMMARY OF SOME OF THE REQUIREMENTS FOLLOW:
 - A. TERMINATE WITH COMPRESSION CONNECTORS, NO RING CUTS OF THE INSULATION, CRIMP ONLY WITH A CRIMP TOOL AND THE CORRECT DIE AS REQUIRED BY THE MANUFACTURER.
 - B. ALL CONDUCTORS TO RECEIVE ANTI-OXIDATIVE COATING DURING INSTALLATION.
 - C. TERMINATING WITH A SET SCREW CONNECTOR, THE SCREW SHALL BE TIGHTENED USING ONLY A TORQUE WRENCH.
 - D. NECA / AA RECOMMENDS BELLVILLE WASHERS WHEN CONNECTING ALUMINUM CONDUCTORS TO COPPER BUS BARS. ABIDE BY ALL NECA / AA RECOMMENDATIONS.
 - E. DO NOT USE PIN CONNECTORS (WIRE ADAPTERS) UNLESS ABSOLUTELY NECESSARY. USE ALL / ANY OTHER OPTIONS, AND IF REQUIRED, PROVE TO ENGINEER BEFORE INSTALLING. IF USED, FOLLOW U.L. GUIDE FOR WIRE CONNECTORS (ZMOW), AND PROVIDE THE SPECIAL TOOLS REQUIRED BY THE MANUFACTURER. DIE-LESS CRIMPERS WILL NOT BE ACCEPTED.

RACEWAY AND BOXES

1. RACEWAYS: UNLESS NOTED OTHERWISE, ALL EXPOSED CONDUIT SHALL BE R.G.S., SCHEDULE 80 AND COVERED 6" BELOW FINISHED GRADE TO BE PVC, SCHEDULE 40. PROVIDE WEATHERPROOF FLEX CONNECTIONS WHERE REQUIRED. CONTRACTOR SHALL PROVIDE JUNCTION AND/OR PULL BOXES WHERE SHOWN ON THE DRAWINGS, OR AS REQUIRED, WHETHER SHOWN ON THE DRAWINGS OR NOT, AND SIZED PER N.E.C. PROVIDE NON-METALLIC ENCLOSURE WITH OPEN BOTTOM AND GASKETED COVER MANUFACTURED BY QUAZITE OR EQUIVALENT WITH DRIVE-OVER COVER ABLE TO WITHSTAND OCCASIONAL NON-DELIBERATE LIGHT VEHICULAR TRAFFIC. LABEL COVER TO SUIT INSTALLATION (I.E. "POWER" "COMMUNICATIONS", "LIGHTING", ETC.) AND INSTALL PER MANUFACTURER'S RECOMMENDATIONS.

A. ABOVE GRADE: R.G.S.

- B. BELOW GRADE: SCHEDULE 40 PVC (UNLESS NOTED OTHERWISE)
- 2. ALL WIRING SHALL BE INSTALLED IN CONDUIT. ALL CONDUIT SHALL BE A MINIMUM OF 3/4".
- 3. CONTRACTOR SHALL PLUG AND CAP EACH END OF SPARE AND EMPTY CONDUITS AND PROVIDE TWO SEPARATE PULL STRINGS - 200 LBS TEST POLYETHYLENE CORD. ALL CONDUIT BENDS SHALL BE A MINIMUM OF 3 T. RADIUS. RGS CONDUITS WHEN SPECIFIED, SHALL MEET UL-6 FOR GALVANIZED STEEL. ALL FITTINGS SHALL BE SUITABLE FOR USE WITH THREADED RIGID CONDUIT. COAT ALL THREADS WITH 'BRITE ZINC' OR 'GOLD GALV'.
- 4. OUTLET BOXES SHALL BE CAST ALLOY WITH THREADED HUBS IN WET/DAMP LOCATIONS AND SPECIAL ENCLOSURES FOR OTHER CLASSIFIED AREAS.
- PROVIDE METAL CONDUIT AND TUBING MANUFACTURED BY ONE OF THE FOLLOWING: ALFLEX CORPORATION; ANAMET INCORPORATED, ANACONDA METAL HOSE; ANIXTER BROTHERS INCORPORATED; CAROL CABLE COMPANY INCORPORATED; ELECTRI-FLEX COMPANY; GRINNELL COMPANY, ALLIED TUBE AND CONDUIT DIVISION; MONOGRAM COMPANY, AFC; REPUBLIC CONDUIT; OR WHEATLAND TUBE COMPANY.
- 6. PROVIDE NONMETALLIC CONDUIT AND TUBING MANUFACTURED BY ONE OF THE FOLLOWING: ANAMET INCORPORATED, ANACONDA METAL HOSE; CANTEX INDUSTRIES, HARSCO CORPORATION; CONDUX INTERNATIONAL, ELECTRICAL PRODUCTS; HUBBELL INCORPORATED, RACO, INCORPORATED; THOMAS & BETTS CORPORATION, CARLON ELECTRICAL PRODUCTS; OR O-Z/GEDNEY, UNIT OF GENERAL SIGNAL.
- 7. PROVIDE CONDUIT BODIES AND FITTINGS MANUFACTURED BY ONE OF THE FOLLOWING: CROUSE-HINDS, DIVISION OF COOPER INDUSTRIES; EMERSON ELECTRIC COMPANY, APPLETON ELECTRIC COMPANY; HUBBELL INCORPORATED, KILLARK ELECTRIC MANUFACTURING COMPANY; THOMAS & BETTS CORPORATION, CARLON ELECTRICAL PRODUCTS; OR O-Z/GEDNEY, UNIT OF GENERAL SIGNAL.
- PROVIDE METAL WIREWAYS MANUFACTURED BY ONE OF THE FOLLOWING: HOFFMAN ENGINEERING COMPANY; KEYSTONE/REES, INCORPORATED; OR SQUARE D COMPANY.
- PROVIDE BOXES, ENCLOSURES, AND CABINETS MANUFACTURED BY ONE OF THE FOLLOWING: CROUSE-HINDS, DIVISION OF COOPER INDUSTRIES; HOFFMAN ENGINEERING COMPANY, FEDERAL-HOFFMAN INCORPORATED; HUBBELL INCORPORATED, RACO INCORPORATED; THOMAS & BETTS, CARLON ELECTRICAL PRODUCTS; O-Z/GEDNEY, UNIT OF GENERAL SIGNAL; ROBROY INDUSTRIES INCORPORATED, ELECTRICAL DIVISION; OR SCOTT FETZER COMPANY, ADALET-PLM.

SAFETY SWITCHES

 ALL DISCONNECT SWITCHES SHALL BE HEAVY-DUTY CONSTRUCTION WITH LOCKABLE HANDLES SIZED AS NOTED ON THE DRAWINGS AND/OR RISER DIAGRAM. PROVIDE NEMA ENCLOSURE AS REQUIRED BY EXPOSURE TYPE. ALL FUSIBLE SWITCHES SHALL BE PROVIDED WITH DUAL ELEMENT FUSES SIZED PER THE EQUIPMENT MANUFACTURER'S RECOMMENDATION.

FUSES

- FUSES SHALL BE DUAL ELEMENT, TIME DELAY CURRENT LIMITING. CONTRACTOR SHALL COORDINATE FUSE SIZES WITH EQUIPMENT MANUFACTURER'S REQUIREMENTS AND PER THE N.E.C.
- 2. PROVIDE FUSES MANUFACTURED FROM ONE OF THE FOLLOWING: COOPER BUSSMAN, INCORPORATED; EAGLE ELECTRIC MANUFACTURING COMPANY INCORPORATED, COOPER INDUSTRIES INCORPORATED; FERRAZ SHAWMUT INCORPORATED.



3500 DEER CREEK RD PALO ALTO, CA 94304 (650) 681-5000



Akron, OH 44311 330.572.2100 Fax: 330.572.2102

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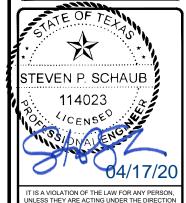
DRAWN BY: HD

CHECKED BY: RP/EPM

INSTALLATION MANAGER: ROBERT CORDOVA

GPD PROJECT NUMBER

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П	С	12.06.18	ISSUED FOR 100% REVIEW
	В	10.31.18	ISSUED FOR 100% REVIEW
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11410 CENTURY OAKS TERRACE (TESLA STATION) AUSTIN, TX 78758


OF A LICENSED PROFESSIONAL ENGINEER, TO ALTER THIS DOCUMENT.

SHEET TITLE

ELECTRICAL GENERAL NOTES

SHEET NUMBER

EN-2

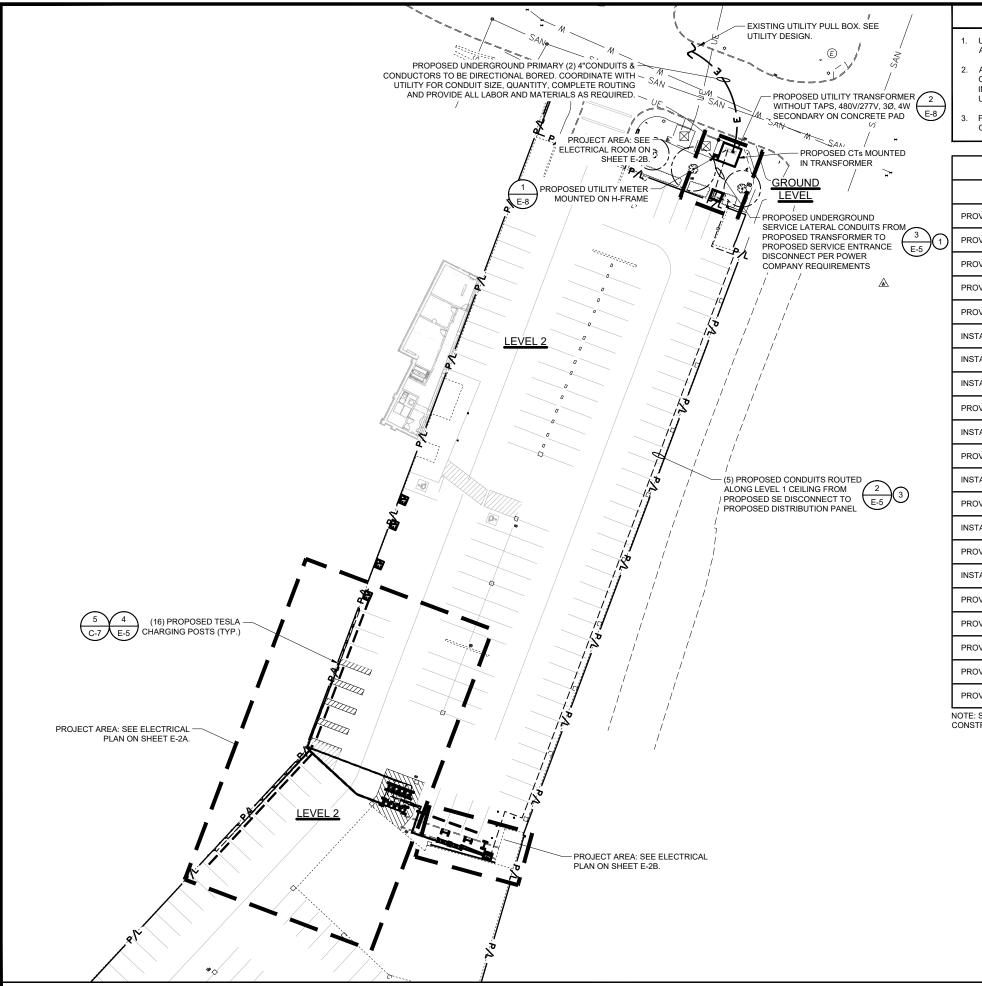

OVERALL UTILITY PLAN

GENERAL SHEET NOTES

- UTILITY EQUIPMENT INSTALLATIONS AND PREP WORK SHALL BE COORDINATED WITH THE APPROPRIATE UTILITY ENGINEER TO ENSURE ACCURACY OF INSTALLATION
- ALL PROPOSED CONDUITS MUST MEET MINIMUM DEPTH REQUIREMENTS AS OUTLINED IN DETAILS ON SHEET E-5, AS WELL AS MAINTAIN A MINIMUM OF 18" CLEAR OF ALL EXISTING OBSTRUCTIONS INCLUDING (BUT NOT LIMITED TO) STORM PIPES, SANITARY PIPES, WATER LINES AND OTHER UNDERGROUND UTILITIES.
- FOR TRAFFIC CONTROL PROCEDURES (IF APPLICABLE), SEE TRAFFIC CONTROL NOTES ON SHEET

ELECTRICAL SCOPE OF WORK RESPONSIBILITIES					
SCOPE	BY UTILITY	BY CONTRACTOR			
PROVIDE PRIMARY SIDE TRENCHING		х			
PROVIDE & INSTALL PRIMARY SIDE CONDUITS W/ PULLWIRE		х			
PROVIDE & INSTALL PRIMARY SIDE CONDUCTORS	Х				
PROVIDE & INSTALL UTILITY TRANSFORMER PAD		х			
PROVIDE UTILITY TRANSFORMER	Х				
INSTALL UTILITY TRANSFORMER	Х				
INSTALL CONNECTIONS AT UTILITY TRANSFORMER (PRIMARY)	Х				
INSTALL CONNECTIONS AT UTILITY TRANSFORMER (SECONDARY)	Х				
PROVIDE METER PEDESTAL		х			
INSTALL METER PEDESTAL		х			
PROVIDE METER BASE		х			
INSTALL METER BASE		х			
PROVIDE METER	Х				
INSTALL METER	Х				
PROVIDE CTs	Х				
INSTALL CTs (INSIDE TRANSFORMER)	Х				
PROVIDE SECONDARY SIDE TRENCHING		х			
PROVIDE & INSTALL SECONDARY SIDE CONDUITS W/ PULLWIRE		х			
PROVIDE & INSTALL SECONDARY SIDE CONDUCTORS		х			
PROVIDE ROAD CUTS / ROAD BORES		х			
PROVIDE & INSTALL PAVEMENT REPLACEMENT		х			

NOTE: SCOPE SHOWN ABOVE WAS PROVIDED BY AUSTIN ENERGY. FIELD VERIFY PRIOR TO CONSTRUCTION.

POWER COMPANY CONTACTS

AUSTIN ENERGY ATTN: JON SANTOS (512) 505-7286 JON.SANTOS@AUSTINENERGY.COM



SCALE: 1"=50'

3500 DEER CREEK RD PALO ALTO, CA 94304 (650) 681-5000



GPD PROJECT NUMBER 2018441.22 DRAWN BY CHECKED BY: RP/EPM

INSTALLATION MANAGER: ROBERT CORDOVA GPD Group, Professional Corporat Texas Registration No. 16477

SIGNED AND SEALED SIGNED AND SEALED E 07.25.19 SIGNED AND SEALED D 03.08.19 ISSUED FOR 100% REVIEW C 12.06.18 ISSUED FOR 100% REVIEW B 10.31.18 ISSUED FOR 100% REVIEW A 10.02.18 ISSUED FOR 50% REVIEW REV DATE



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11410 CENTURY OAKS TERRACE (TESLA STATION) AUSTIN, TX 78758

SHEET TITLE

OVERALL UTILITY PLAN

SHEET NUMBER

E-1

DC CHAR	GING POS	T LENGTI	HS (FEET)	
CABINET	POST	LF	***EST***	
1	1A	141	163	
'	1B	132	154	
2	2A	121	143	
2	2B	108	130	
3	3A	95	117	
3	3B	84	106	
4	4A	70	92	
4	4B	64	86	
5	5A	62	84	
5	5B	71	93	
6	6A	83	105	
0	6B	92	114	
7	7A	103	125	
,	7B	113	135	
8	8A	124	146	
0	8B	134	156	
TOTAL LENGTH OF DC WIRE= 3898				
TOTAL LENGTH OF GND Cu & 1949 COMM CABLE WIRE=				

AC CHARGING CABINET LENGTHS (FEET)				
SWITCHGEAR	CABINET	LF	**EST**	
CIRCUIT 1	1	347	363	
CIRCUIT 2	2	351	367	
CIRCUIT 3	3	355	371	
CIRCUIT 4	4	359	375	
CIRCUIT 5	5	359	375	
CIRCUIT 6	6	357	373	
CIRCUIT 7	7	355	371	
CIRCUIT 8	8	353	369	
TOTAL LENGTH OF AC WIRE= 11856				
TOTAL LENGTH OF GND Cu WIRE= 2964				
SEE SHEET E-3 FOR FEEDER SCHEDULE				

SEE SHEET E-3 FOR FEEDER SCHEDULE
TOTAL LENGTH OF AC WIRE =
SUM OF EST LENGTH x
4 WIRES PER CABINET
TOTAL LENGTH OF GND Cu =
SUM OF EST LENGTHS

UTILITY SERVICE LATERAL LENG	THS (FEE	T)
UTILITY TRANSFORMER	LF	*EST*
TO SE DISCONNECT	26	48
TOTAL LENGTH OF WIRE PER COND	192	
NUMBER OF WIRE FILLED CONDU	IT=	5
TOTAL LENGTH OF WIRE=	960	

- * AC UTILITY SERVICE CONDUCTORS: 22 FEET IS ADDED TO THE HORIZONTAL RUN LENGTH TO ACCOUNT FOR BURIED DEPTH. ** AC CONDUCTORS:
- 16 FEET IS ADDED TO THE HORIZONTAL RUN LENGTH TO ACCOUNT FOR VERTICAL RUN.
 *** DC CONDUCTORS:
- 22 FEET IS ADDED TO THE HORIZONTAL RUN LENGTH TO ACCOUNT FOR VERTICAL RUN.

GENERAL SHEET NOTES

- CONDUCTOR LENGTHS ARE ESTIMATES ONLY. LENGTHS ARE BASED ON DIAGRAMMATICAL MEASUREMENTS AND APPROXIMATED BURIED DEPTHS. THE EXACT ROUTING PATH AND CONDUCTOR RUN LENGTHS SHALL BE DETERMINED BY CONTRACTOR IN FIELD BASED ON PHYSICAL MEASUREMENTS. CONTRACTOR SHALL ORDER CONDUCTORS BASED ON FIELD MEASUREMENTS (MUST BE APPROVED BY TESLA INSTALLATION MANAGER)
- 2. " # " DENOTES FEEDER REFERENCE. REFER TO SHEET E-3 FOR FEEDER/CIRCUIT SCHEDULE.
- CONTRACTOR SHALL REFER TO CIVIL SHEETS FOR EXISTING LANDSCAPING TO REMAIN AND PROPOSED LANDSCAPING.
- 4. CONTRACTOR SHALL HAND DIG AROUND ALL EXISTING UTILITIES.
- CONDUIT ELBOWS SHALL BE SIZED PER MANUFACTURER ALLOWABLE FILL.
 SEE FEEDER SCHEDULE FOR CONDUIT & CONDUCTOR SPECIFICATIONS.
- ALL CONDUITS ACCESSIBLE TO THE PUBLIC OR WHICH CAN BE DAMAGED SHALL BE RIGID GALVANIZED STEEL.
- 7. CONTRACTOR SHALL INSTALL PULL BOXES INSIDE PARKING GARAGE AS REQUIRED.


- 3. CONTRACTOR SHALL MAINTAIN MINIMUM HEAD ROOM IN PARKING GARAGE AS REQUIRED BY GARAGE OWNER FOR ALL NEW CONSTRUCTION.
- CONTRACTOR SHALL USE GROUND PENETRATING RADAR TO LOCATE ALL STEEL TENSION WIRES AND REBAR IN CONCRETE BEFORE DRILLING.
- CONTRACTOR SHALL PROVIDE WATER TIGHT & FIRE TIGHT FITTINGS IN ALL PENETRATIONS.
- CONTRACTOR SHALL COORDINATE ALL BUILDING OUTAGES WITH BUILDING OWNER.
- 12. CORE DRILLED HOLES SHALL BE SPACED 6" APART MINIMUM, EDGE TO EDGE. CONTRACTOR SHALL VERIFY REINFORCEMENT LOCATION IN EXISTING CONCRETE PRIOR TO DRILLING AND MAINTAIN 6" CLEARANCE FROM EDGE OF HOLE TO EXISTING REINFORCEMENT. PROVIDE WATER & FIRE SEALANT AFTER CONDUITS HAVE BEEN INSTALLED. INFORM ENGINEER IMMEDIATELY OF ANY INTERFERENCES OR CABLES FOUND THAT WOULD PREVENT CONDUITS FROM BEING LAID OUT AS SPECIFIED.





330.572.2100 Fax: 330.572.2102

DRAWN BY:	HD
CHECKED BY:	RP/EPM
INSTALLATION MANAGER	R: ROBERT CORDOVA
$\overline{}$	
GPD Group, Profe	ssional Corporati
Taulan Danikanaina	NI- 40477

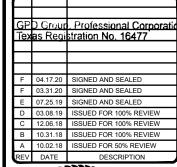



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11410 CENTURY OAKS TERRACE (TESLA STATION) AUSTIN, TX 78758

SHEET TITLE


ELECTRICAL

EQUIPMENT PLAN

SHEET NUMBER

SCALE: 1"=20'

E-2A

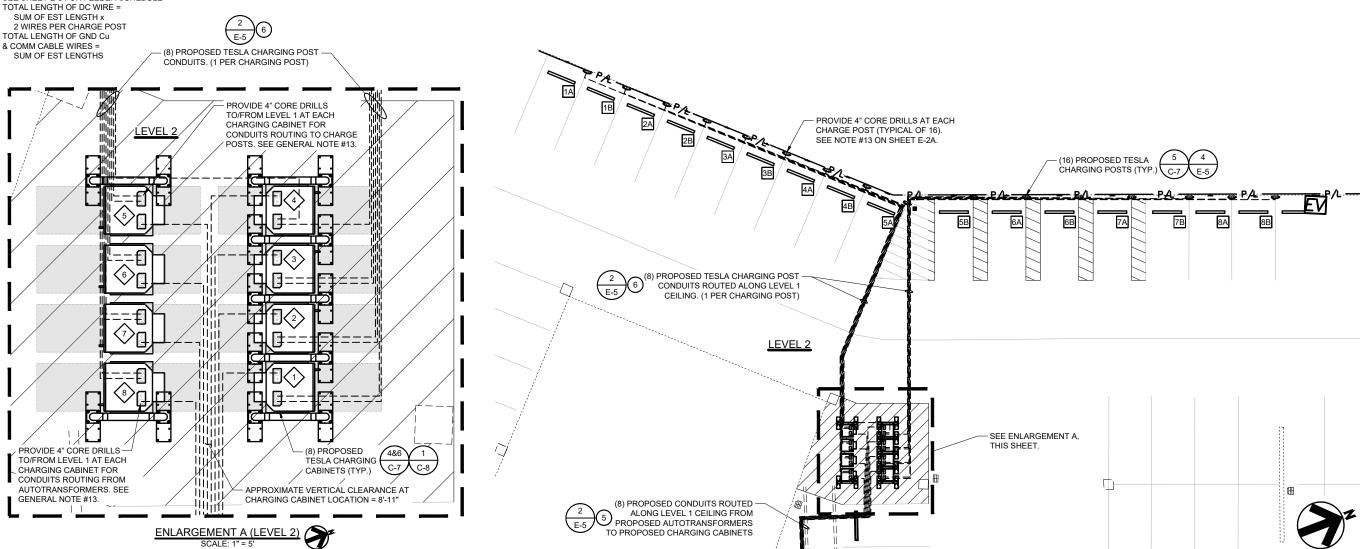

ELECTRICAL EQUIPMENT PLAN

ELECTRICAL KEYNOTES (#)

- CONTRACTOR SHALL PROVIDE 1-1/4" RGS CONDUIT AND PULLSTRING WITH BUSHINGS ON BOTH ENDS FROM PROPOSED CT COMPARTMENT TO PROPOSED UTILITY METER
- 2. CONTRACTOR SHALL COORDINATE EXACT LOCATION OF H-FRAME MOUNTED METER WITH

SERVICE ENTRANCE DISCONNECT SWITCH WITH 1600A FUSES, NEMA 3R, GROUND FAULT RELAY MOUNTED ON

PER NEC AND LOCAL JURISDICTION.

NUMBERS OF SERVICES, LOCATIONS OF EACH DISCONNECT

CONCRETE PAD. PROVIDE SERVICE PLAQUES ON THIS AND ALL OTHER ELECTRICAL SERVICES TO BUILDING, IDENTIFYING

GENERAL SHEET NOTES

- CONDUCTOR LENGTHS ARE ESTIMATES ONLY. LENGTHS ARE BASED ON DIAGRAMMATICAL MEASUREMENTS AND APPROXIMATED BURIED DEPTHS. THE EXACT ROUTING PATH AND CONDUCTOR RUN LENGTHS SHALL BE DETERMINED BY CONTRACTOR IN FIELD BASED ON PHYSICAL MEASUREMENTS. CONTRACTOR SHALL ORDER CONDUCTORS BASED ON FIELD MEASUREMENTS (MUST BE APPROVED BY TESLA INSTALLATION MANAGER).
- # # DENOTES FEEDER REFERENCE. REFER TO SHEET E-3 FOR FEEDER/CIRCUIT SCHEDULE.
- CONTRACTOR SHALL REFER TO CIVIL SHEETS FOR EXISTING LANDSCAPING TO REMAIN AND PROPOSED LANDSCAPING.
- 4. CONTRACTOR SHALL HAND DIG AROUND ALL EXISTING UTILITIES.
- CONDUIT ELBOWS SHALL BE SIZED PER MANUFACTURER ALLOWABLE FILL.
 SEE FEEDER SCHEDULE FOR CONDUIT & CONDUCTOR SPECIFICATIONS.
- ALL CONDUITS ACCESSIBLE TO THE PUBLIC OR WHICH CAN BE DAMAGED SHALL BE RIGID GALVANIZED STEEL.
- CONTRACTOR SHALL INSTALL PULL BOXES INSIDE PARKING GARAGE AS
- CONTRACTOR SHALL MAINTAIN MINIMUM HEAD ROOM IN PARKING GARAGE AS

REQUIRED BY GARAGE OWNER FOR ALL NEW CONSTRUCTION.

- CONTRACTOR SHALL USE GROUND PENETRATING RADAR TO LOCATE ALL STEEL TENSION WIRES AND REBAR IN CONCRETE BEFORE DRILLING.
- CONTRACTOR SHALL PROVIDE WATER TIGHT & FIRE TIGHT FITTINGS IN ALL PENETRATIONS.
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GPD PROJECT NUMBER: 2018441.22

DRAWN BY: HD

CHECKED BY: RP/EPM

INSTALLATION MANAGER: ROBERT CORDOVA

GP Tex	D Group as Regi	. Professional Corporati stration No. 16477
F	04.17.20	SIGNED AND SEALED
F	03.31.20	SIGNED AND SEALED
Е	07.25.19	SIGNED AND SEALED
D	03.08.19	ISSUED FOR 100% REVIEW
С	12.06.18	ISSUED FOR 100% REVIEW
В	10.31.18	ISSUED FOR 100% REVIEW
Α	10.02.18	ISSUED FOR 50% REVIEW
REV	DATE	DESCRIPTION



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> 11410 CENTURY OAKS TERRACE (TESLA STATION) AUSTIN, TX 78758


> > SHEET TITLE

ELECTRICAL EQUIPMENT PLAN

SHEET NUMBER

SCALE: 1"=20'

E-2B

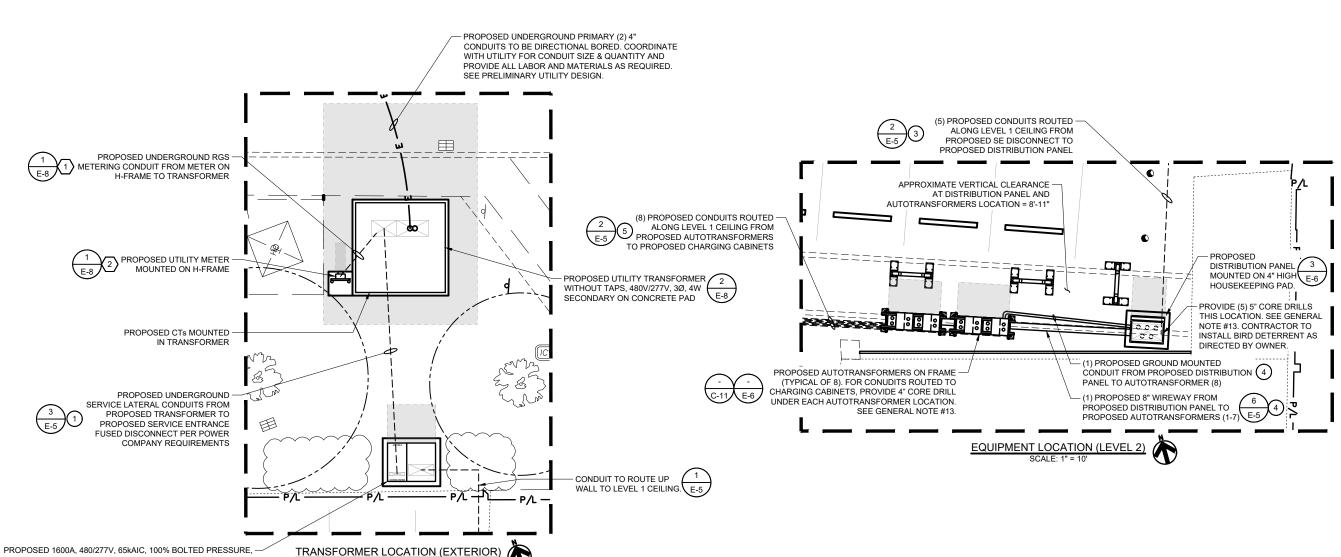

ELECTRICAL EQUIPMENT PLAN

GENERAL SHEET NOTES

- NEUTRAL MUST BE INCLUDED FOR PROPER OPERATION OF TESLA SUPERCHARGERS.
- PROPOSED UTILITY CTs SHALL BE LOCATED IN UTILITY APPROVED CT COMPARTMENTS MOUNTED IN TRANSFORMER. PROPOSED METER SHALL 9. BE MOUNTED ON H-FRAME.
- 3. SEE SHEET E-4 FOR PANEL SCHEDULES.
- ALL CONDUIT FURNISHED AND INSTALLED BY CONTRACTOR. ALL WIRING FURNISHED BY TESLA AND INSTALLED BY CONTRACTOR.
- ALL BUSHINGS AND INTERNAL WIRING OF PROPOSED SERVICE EQUIPMENT PROVIDED BY MANUFACTURER. ANY MODIFICATIONS SHALL REQUIRE FINGINFERING APPROVAL PRIOR TO ANY CHANGES REING MADE
- VERIFY AVAILABLE FAULT CURRENT AT THE SECONDARY OF THE UTILITY TRANSFORMER WITH THE POWER COMPANY. CONDUCT A FAULT CURRENT ANALYSIS TO DETERMINE THE INTERRUPTING CAPACITY (AIC RATING) OF THE ELECTRICAL EQUIPMENT.
- 7. CONTRACTOR SHALL PERFORM ARC FLASH CALCULATIONS AS REQUIRED IN THE FOLLOWING: NFPA 70; NFPA 70E; OSHA 29; AND IEEE STANDARDS 1584. CONTRACTOR SHALL OBTAIN ALL NECESSARY INFORMATION FROM POWER COMPANY TO CALCULATE FLASH PROTECTION BOUNDARIES, INCIDENT ENERGY LEVELS, AND SHALL DETERMINE MINIMUM PPE REQUIREMENTS FOR COMPLETING THE WARNING LABELS. PROVIDE WARNING LABELS CONTAINING ALL THE LATEST INFORMATION AS REQUIRED BY LOCAL JURISDICTION, STATE AND FEDERAL CODES AND LAWS

- 8. ALL ALUMINUM (AI) CONDUCTORS TO RECEIVE ANTI-OXIDATIVE COATING DURING INSTALLATION. ALL OTHER CONDUCTORS ARE COPPER UNLESS NOTED OTHERWISE.
- ALL CONDUITS ACCESSIBLE TO THE GENERAL PUBLIC OR WHICH CONDUITS CAN BE DAMAGED SHALL BE RIGID GALVANIZED STEEL.
- 10. THE CHARGING CABINETS AND THE CHARGING POSTS USED ON THIS PROJECT COMPLY WITH THE FOLLOWING STANDARDS:
- IEC 61851-23 : 2014 / EN 61851 -23: 2014
 UL 2202: 2009 (R2012)

IDEAL

SPACING

MINIMUM SPACING.

- CAN CSA C22.2 NO. 107.1-01 (R2011)
- 11. THE AFOREMENTIONED STANDARDS IDENTIFY THE REQUIREMENTS MET BY THE EQUIPMENT, INCLUDING BUT NOT LIMITED TO:
- PROTECTION AGAINST ELECTRIC SHOCK
- OVERLOAD AND SHORT CIRCUIT PROTECTION
 FAULT PROTECTION
- DEGREES OF PROTECTION AGAINST ACCESS TO HAZARDOUS LIVE PARTS
- THE INTERNAL COMPONENTS OF THE SYSTEM ARE PROPRIETARY, ANY QUESTIONS CONCERNING ACTUAL INTERNAL PROTECTIVE DEVICES MUST BE COORDINATED DIRECTLY WITH TESLA.

4	FEEDER/CIRCUIT SCHEDULE						
	NO	FROM	TO	CONFIGURATION			
	1	UTILITY TRANSFORMER/ METERING	PROPOSED SERVICE EQUIPMENT;INCOMING	(3) 600 MCM AI (XHHW-2, 90°C) (1) 600 MCM AI NEUT (XHHW-2, 90°C) IN EACH (5) 4" PVC CONDUITS			
	2	PROPOSED SERVICE EQUIPMENT; INCOMING	PROPOSED SERVICE EQUIPMENT; 1600A TRIP MAIN BREAKER	FACTORY INSTALLED 1600A BUSS (BY MANUFACTURER)			
	3	PROPOSED SERVICE EQUIPMENT; 1600A TRIP MAIN BREAKER	PROPOSED DISTRIBUTION PANEL	(3) 600 MCM AI (XHHW-2, 90°C) (1) 600 MCM AI NEUT (XHHW-2, 90°C) (1) 500 MCM Cu GND (XHHW-2, 90°C) (1) IN EACH (5) 4" RGS CONDUITS			
	4	PROPOSED DISTRIBUTION PANEL	PROPOSED TESLA AUTOTRANSFORMERS 1-8	(3) 250 MCM Cu (XHHW-2, THWN-2, OR RW90) (1) 250 MCM Cu NEUT (XHHW-2, THWN-2, OR RW90) (1) #4 AWG Cu GND IN 3" RGS CONDUIT & 8" WIREWAY (SEE SHEET E-2B)			
	5	PROPOSED TESLA AUTOTRANSFORMERS 1-8	PROPOSED TESLA CHARGING CABINETS 1-8	(3) 250 MCM Cu (XHHW-2, THWN-2, OR RW90) (1) 250 MCM Cu NEUT (XHHW-2, THWN-2, OR RW90) (1) #4 AWG Cu GND IN 3" RGS CONDUIT.			
	6	PROPOSED TESLA CHARGING CABINETS 1-8	PROPOSED TESLA CHARGING POSTS 1-16	(2) 250 MCM AI (XHHW-2, THWN-2, OR RW90) (1) #6 AWG Cu GND (1) 600V COMM CABLE IN 3" RGS CONDUIT OR 8" WIREWAY. SEE PLAN.			
ı	7	SERVICE GEAR POWER SUPPLY THRU 5 KVA TRANSFORMER (BY MANUFACTURER)	DISTRIBUTION PANEL 'DP'	FACTORY INSTALLED CABLING (BY MANUFACTURER)			
	8	DISTRIBUTION PANEL 'DP'	PROPOSED 20A GFCI DUPLEX OUTLET	FACTORY INSTALLED CABLING (BY MANUFACTURER)			

**NOTE: CONTRACTOR SHALL INSTALL THE FOLLOWING WHERE APPLICABLE: -PVC BELOW GRADE -RGS 8'-0" OR LESS ABOVE GRADE OR PARKING

-RGS 8'-0" OR LESS ABOVE GRADE OR PARKING GARAGE FLOOR LEVEL

-EMT 8'-0" MINIMUM ABOVE PARKING GARAGE FLOOR LEVEL AND WHERE NOT SUBJECT TO DAMAGE. CONTRACTOR SHALL VERIFY WITH ELECTRICAL INSPECTOR IF EMT IS APPROVED AT THIS PROJECT PRIOR TO ROUGH-IN.





1	GPD PROJECT NUMBER:	2018441.22
	DRAWN BY:	HD
	CHECKED BY:	RP/EPM
	INSTALLATION MANAGER:	ROBERT CORDOVA

		. Professional Corporationstration No. 16477
F		
F	04.17.20	SIGNED AND SEALED
F E	03.31.20 07.25.19	SIGNED AND SEALED SIGNED AND SEALED
D C	03.08.19 12.06.18	ISSUED FOR 100% REVIEW ISSUED FOR 100% REVIEW
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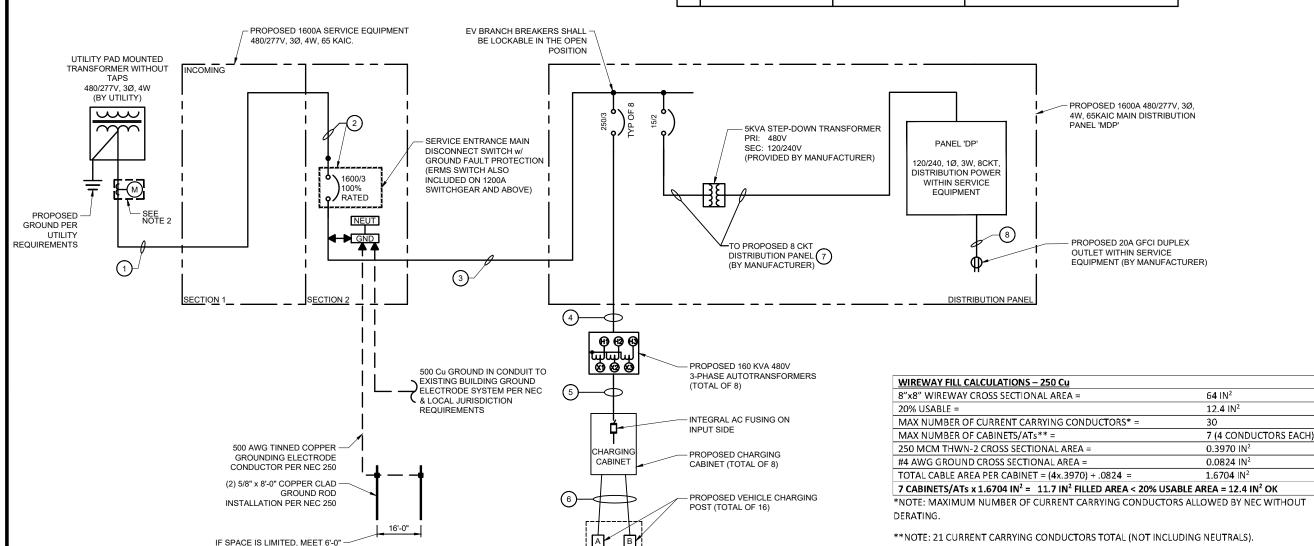
> 11410 CENTURY OAKS TERRACE (TESLA STATION) AUSTIN, TX 78758

> > SHEET TITLE


SYSTEM ONE-LINE DIAGRAM

SHEET NUMBER

E-3



SYSTEM ONE-LINE DIAGRAM

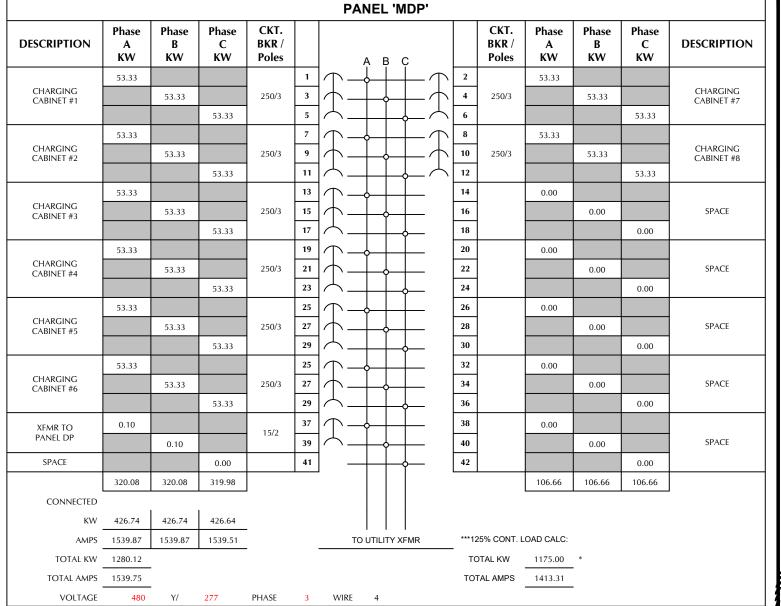

SPECIFICATIONS: SERVICE ENTRANCE RATED, 1600A BUS, 65 KAIC, 100% RATED MCB, NEMA 3R ENCLOSURE

***THE SUM OF THE TOTAL CONNECTED LOADS (NONCONTINUOUS LOAD PLUS THE CONTINUOUS LOAD) TERMINATE IN AN OVERCURRENT DEVICE WHERE BOTH THE OVERCURRENT DEVICE AND ITS ASSEMBLY ARE LISTED FOR OPERATION AT 100 PERCENT OF THEIR RATING.

PANEL BOARD NOTES

- 1. PANELS ARE LOCATED WITHIN PROPOSED SERVICE EQUIPMENT AND IS PROVIDED AND INSTALLED BY MANUFACTURER.
- 2. PROVIDE EQUIPMENT WITH SUFFICIENT INTERRUPTING CAPACITY (AIC) REQUIRED FOR A SAFE INSTALLATION. AIC RATING NOTED ON EACH PANELBOARD SCHEDULE IS MINIMUM RATING ACCEPTED WITHOUT ADDITIONAL DOCUMENTATION THAT INDICATES DIFFERENTLY.
- 3. CIRCUITS SHALL BE REARRANGED AS REQUIRED TO MAINTAIN THE MOST BALANCED LOADS ON EACH PHASE WITHIN EACH PANEL. PROVIDE TYPED PANEL DIRECTORY MOUNTED PER MANUFACTURERS RECOMMENDATIONS WITH SERVICE EQUIPMENT.
- 4. OCPD FOR CHARGING CABINETS ARE CALCULATED AS FOLLOWS: 192A AC INPUT TO CABINET x 1.25 = 240A ==> 250A BRANCH BREAKER REQUIRED





GPD PROJECT NUME	BER: 2018441.22
DRAWN BY:	HD
CHECKED BY:	RP/EPM
INSTALLATION MANA	AGER: ROBERT CORDOVA

330.572.2100 Fax: 330.572.2102

li			
	GP	D Group	. Professional Corporati
	Tex	as Regi	stration No. 16477
	F	04.17.20	SIGNED AND SEALED
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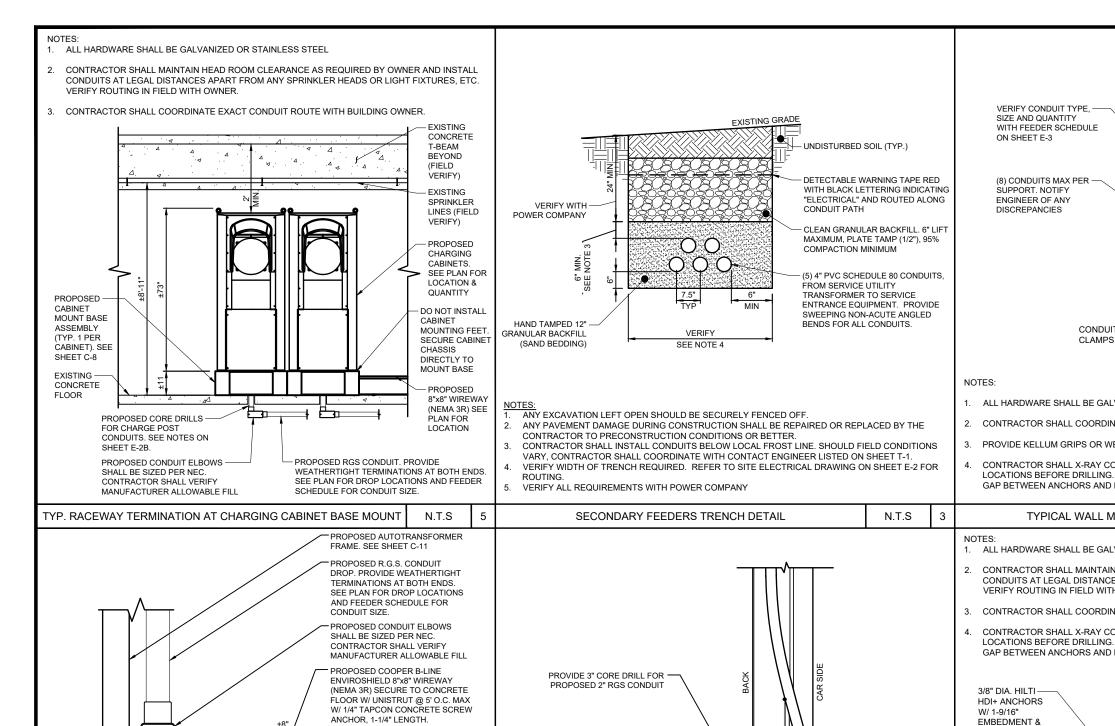
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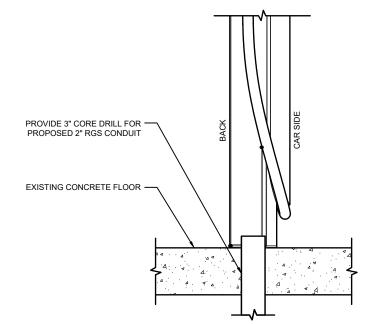
PANEL SCHEDULES

SHEET NUMBER

E-4

DETAIL NOT USED N.T.S 2 PANEL SCHEDULE 'MDP' N.T.S





NOTES

CONTRACTOR SHALL X-RAY CONCRETE SLAB/WALL TO FIELD VERIFY EXISTING REINFORCEMENT LOCATIONS BEFORE CORE DRILLING.


WITH FEEDER SCHEDULE EXISTING WALL UNISTRUT @ 10' O.C. MAX. RATED STRENGTH OF UNISTRUT SHALL BE SELECTED TO SUIT APPLICABLE LOADS 3/8" DIA. HILTI HDI+ ANCHORS W/ 1-9/16" CONDUIT EMBEDMENT & MIN. **EDGE DISTANCE OF 5"**

- 1. ALL HARDWARE SHALL BE GALVANIZED OR STAINLESS STEEL
- 2. CONTRACTOR SHALL COORDINATE EXACT CONDUIT ROUTE WITH BUILDING OWNER.
- 3. PROVIDE KELLUM GRIPS OR WEDGES TO SUPPORT ALL RISER CABLES AT TOP OF RUN
- CONTRACTOR SHALL X-RAY CONCRETE SLAB TO FIELD VERIFY EXISTING REINFORCEMENT LOCATIONS BEFORE DRILLING. CONTRACTOR SHALL TAKE GREAT CARE TO ENSURE AT LEAST 3" GAP BETWEEN ANCHORS AND EXISTING REINFORCEMENT AND STRESSING TENDONS.

TYPICAL WALL MOUNTED CONDUIT DETAIL

N.T.S


- ALL HARDWARE SHALL BE GALVANIZED OR STAINLESS STEEL
- CONTRACTOR SHALL MAINTAIN HEAD ROOM CLEARANCE AS REQUIRED BY OWNER AND INSTALL CONDUITS AT LEGAL DISTANCES APART FROM ANY SPRINKLER HEADS OR LIGHT FIXTURES, ETC. VERIFY ROUTING IN FIELD WITH OWNER.
- 3. CONTRACTOR SHALL COORDINATE EXACT CONDUIT ROUTE WITH BUILDING OWNER.
- CONTRACTOR SHALL X-RAY CONCRETE SLAB TO FIELD VERIFY EXISTING REINFORCEMENT LOCATIONS BEFORE DRILLING, CONTRACTOR SHALL TAKE GREAT CARE TO ENSURE AT LEAST 3" GAP BETWEEN ANCHORS AND EXISTING REINFORCEMENT AND STRESSING TENDONS

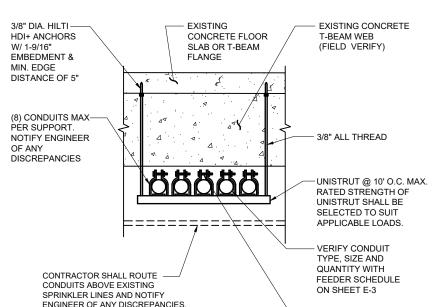





GPD PROJECT NUMBER 2018441.22 CHECKED BY RP/EPN INSTALLATION MANAGER: ROBERT CORDOV

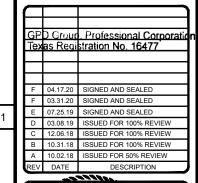



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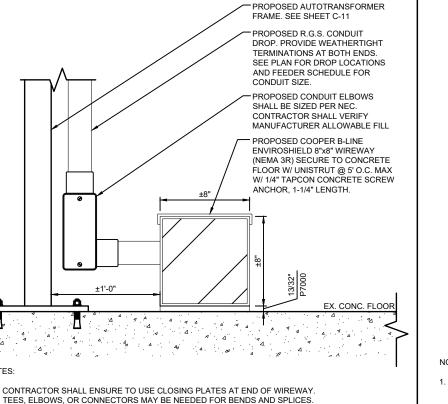
> 11410 CENTURY OAKS TERRACE (TESLA STATION) AUSTIN, TX 78758

> > SHEET TITLE

ELECTRICAL DETAILS

SHEET NUMBER

E-5



- CONTRACTOR SHALL ENSURE TO USE CLOSING PLATES AT END OF WIREWAY
- CONTRACTOR SHALL X-RAY CONCRETE SLAB TO FIELD VERIFY EXISTING REINFORCEMENT LOCATIONS BEFORE DRILLING. CONTRACTOR SHALL TAKE GREAT CARE TO ENSURE AT LEAST 3" GAP BETWEEN ANCHORS AND EXISTING REINFORCEMENT AND STRESSING TENDONS.
- CUT PENETRATION THROUGH WIREWAY AT CHARGING POST LOCATIONS TO ROUTE CABLE. PROVIDE WEATHERTIGHT TERMINATIONS AT BOTH ENDS.
- GROUND/BOND WIREWAY PER NEC.

CONDUIT DROP INTO WIREWAY DETAIL

N.T.S

CHARGING POST CONDUCTOR ROUTING DETAIL


N.T.S

MAINTAIN HEAD ROOM CLEARANCE


TYPICAL CEILING MOUNTED CONDUIT DETAIL


N.T.S

CONDUIT CLAMPS

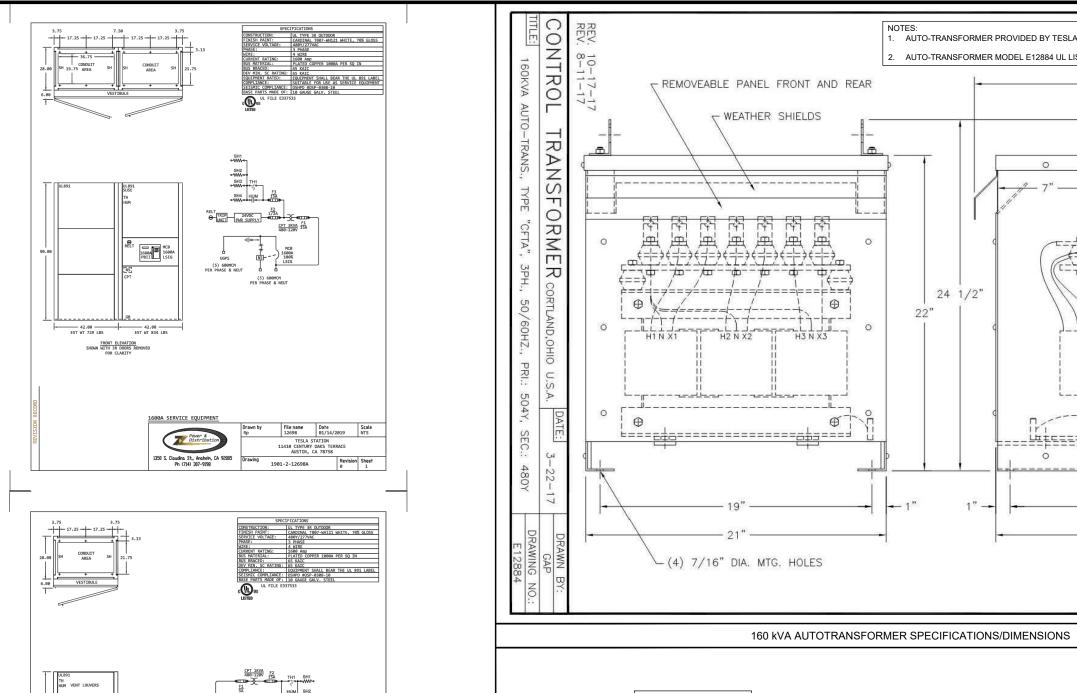

N.T.S

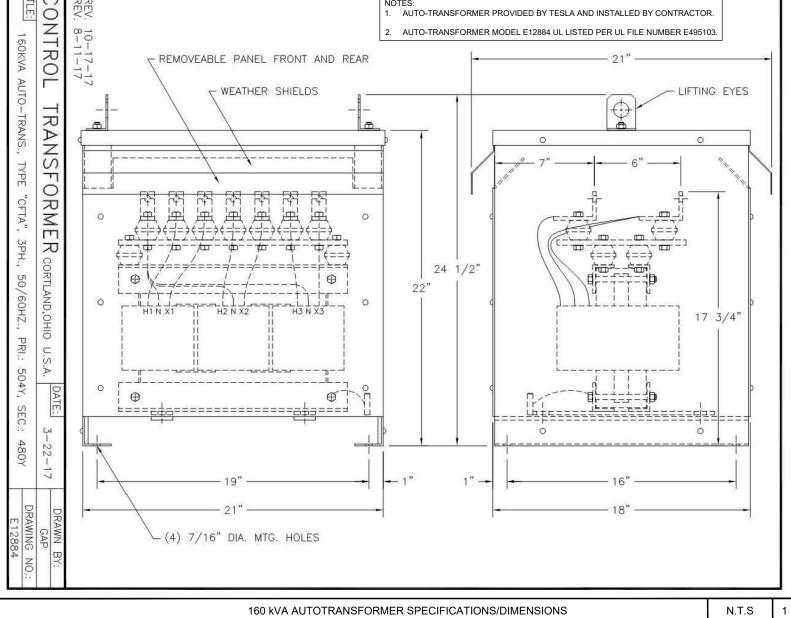

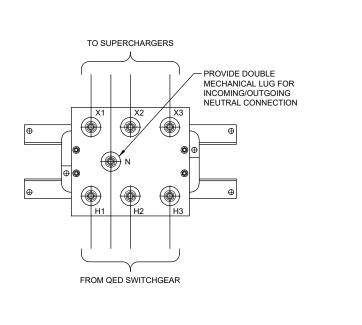



3500 DEER CREEK RD PALO ALTO, CA 94304 (650) 681-5000

DRAWN BY CHECKED BY: RP/EPM INSTALLATION MANAGER: ROBERT CORDOVA E 07.25.19 SIGNED AND SEALED D 03.08.19 ISSUED FOR 100% REVIEW C 12.06.18 ISSUED FOR 100% REVIEW B 10.31.18 ISSUED FOR 100% REVIEW A 10.02.18 ISSUED FOR 50% REVIEW REV DATE

2018441.22

GPD PROJECT NUMBER:

FOR REFERENCE ONLY


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> 11410 CENTURY OAKS TERRACE (TESLA STATION) AUSTIN, TX 78758

AUTOTRANSFORMER DETAILS

E-6

N.T.S

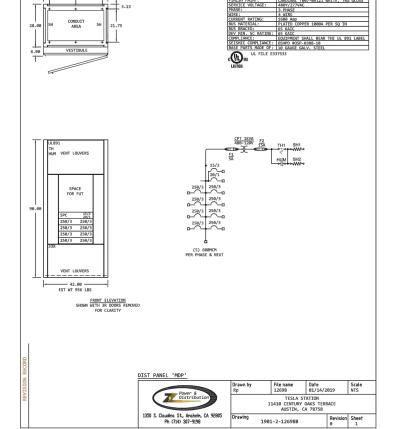

SERVICE ENTRANCE FUSED DISCONNECT SPECIFICATIONS

PHASE 1 IN PHASE 1 OUT PHASE 2 IN PHASE 2 OUT PHASE 3 IN PHASE 3 OUT **NEUTRAL OUT** GROUND OUT GROUND IN **GROUND LUG** PROVIDED WITHIN CASE

CONNECTION DIAGRAM FOR AUTOTRANSFORMERS

1438-08

1438

Sheet 1 of 2 03/06/06 CIVIL


PADS, CLEARANCES AND BARRIERS CLEARANCES FOR URD PADS ONLY





PADS, CLEARANCES AND BARRIERS

1438-08 CLEARANCES FOR URD PADS ONLY

NOTE: ALL CLEARANCE MEASUREMENTS SHOWN BELOW ARE SUBJECT TO THE PARAMETERS FOR CLEARANCES ON PADS, SEE PAGE 1438-08A.

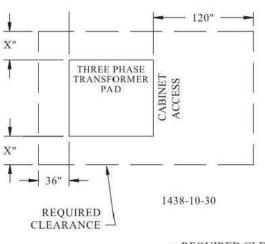

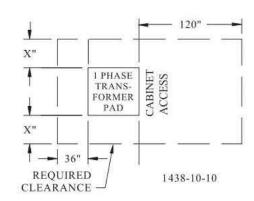

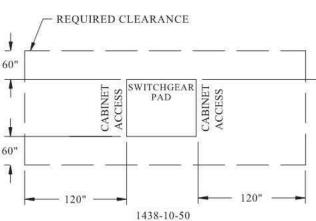

CLEARANCE MEASUREMENTS SHOWN BELOW ARE STANDARD CLEARANCES FOR AE URD.

PER CITY ORDINANCE, THERE SHALL BE NO TREES, SHRUBERY, FENCES ETC., WITHIN THE CLEARANCE AREA.

CONTACT AE DESIGN FOR ANY QUESTIONS OR FURTHER DETAILS REGARDING THE CLEARANCES.

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CIVIL

PADS, CLEARANCES AND BARRIERS PARAMETERS FOR CLEARANCES ON PADS

1438-08A Sheet 2 of 2 3/06/06

1438-08A PARAMETERS FOR CLEARANCES ON PADS

Minimum clearances required for all pad-mount transformer pads (and other padmounted electrical equipment) applicable only to brick or masonry structures with minimum 2-hour fire rating except as noted.

- 1. Hot-Stick use area-10 ft-open area or clearance to adjacent building or structure.
- 2. Sides without operators or controls-3 ft-open area from any <u>removable ventilated</u> obstruction (fence).
- Sides with operators or controls-5 ft-open area from any <u>removable ventilated</u> obstruction (fence).
- 4. All sides-20 ft-clearance from edge of oil filled equipment pad to fire escape.
- Any side when pad is adjacent to brick or masonry building or structure-5 ft-minimum horizontal clearance from side edges of equipment pad to building or structure.
- 6. Any side when pad is adjacent to brick or masonry building or structure-5 ft-minimum lateral clearance from edge of pad for windows, doors, and ventilating ducts.
- Any side when pad is adjacent to <u>non</u> brick or masonry building or structure-12 ft- <u>horizontal</u> clearance from edge of <u>oil filled equipment</u> pad to <u>non</u> brick or masonry building or fixed structure.
- Any side when pad is adjacent to windows, doors, or ventilating ducts-12 ft-vertical clearance from grade for windows, doors, and ventilating ducts when <u>lateral</u> clearance is less than 5 ft from oil filled equipment pad.
- 9. Any side when pad is adjacent to windows, doors, or ventilating ducts-12 ft-horizontal clearance from edge of oil filled equipment pad to building or fixed structure, if a window, door, or ventilating duct is less than 12 ft from grade or less than 5 ft of lateral separation.
- 10. Vertical clearance above the pad and the total minimum clearance area surrounding the pad NO COVERING, BUILDING, OR STRUCTURE OF ANY KIND IS ALLOWED DIRECTLY ABOVE THE PAD OR THE MINIMUM EQUIPMENT AREA ASSOCIATED WITH THE PAD.

Contact AE Design for any questions or further details regarding the above.

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3500 DEER CREEK RD PALO ALTO, CA 94304 (650) 681-5000

GPD	GPD PROJECT NUMBER: 2018441.22				
DRA	DRAWN BY: HD				
CHE	CHECKED BY: RP/EPM				
INST	TALLATION	MANAGER: ROBERT CORDOVA			
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F	04.17.20	SIGNED AND SEALED			
F	03.31.20	SIGNED AND SEALED			
Е	07.25.19	SIGNED AND SEALED			
D	03.08.19	ISSUED FOR 100% REVIEW			
С	12.06.18	ISSUED FOR 100% REVIEW			
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Α	10.02.18	ISSUED FOR 50% REVIEW			

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DESCRIPTION

REV DATE

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> 11410 CENTURY OAKS TERRACE (TESLA STATION) AUSTIN, TX 78758

> > SHEET TITLE

UTILITY DETAILS

SHEET NUMBER

E-7

TRANSFORMER CLEARANCE DETAIL N.T.S 2 TRANSFORMER CLEARANCE PARAMETERS N.T.S 1

1438-90

Sheet 1 of 2 03/06/06


CIVIL

PADS, CLEARANCES AND BARRIERS



PAD CIP 3PH XFMR 10FT X 10FT (75-2500KVA)

1438-90 PAD CIP 3PH XFMR 10FT X 10FT (75-2500KVA)

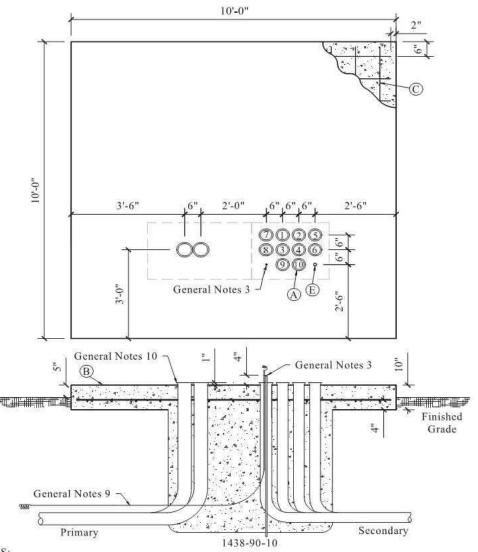

- A. FOR ALL 3 PHASE TRANSFORMER SIZES, A MAXIMUM OF 10 CONDUITS AND 10 SETS OF CABLE PER PHASE, AS SPECIFIED BY AE DISTRIBUTION DESIGN, CAN BE INSTALLED IN THE ARRANGEMENT AND NUMERICAL ORDER AS SHOWN.
- B. TOP OF SLAB 5" ABOVE FINISHED GRADE,
- C. 1/2 IN. GRADE 60 REINFORCED STEEL RODS 9" ON CENTER.
- D. REFER TO GENERAL NOTES ON SECTION 1438-55 FOR DETAILS ON TRANSFORMER CONCRETE PAD CONSTRUCTION.
- E. WHEN METERING AT THE TRANSFORMER, A 1.25" CONDUIT SHALL BE INSTALLED.

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1-11C SHEET 1 OF 1

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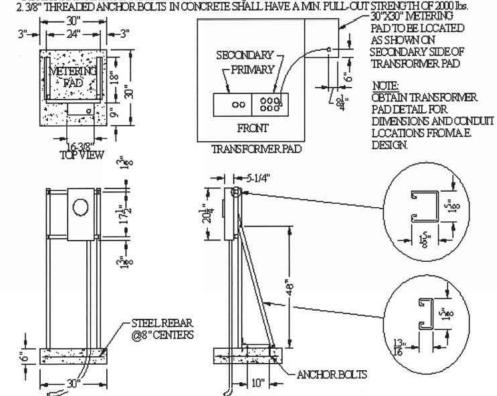
METERING

SIVI SOCKET ENCLOSURE TYPICAL INSTALLATION



MATERIAL NOTES:

I. CONSTRUCT SUPPORT STRUCTURE USING 12-GAUGE STEEL-SLOTTED CHANNEL UNISTRUT METAL FRAMING, ANGLE FITTINGS, BOLTS AND NUTS AS SHOWN THE SUPPORT STRUCTURE SHALL BE STATIONARY. ADDITIONAL BRACING MAY BEREQUIRED.



SIDEVIEW

- NOTES: 13 TERMINAL 3 PHASE (271/480 ONLY!) CTRATED

 1. METERING AT THE TRANSFORMER PAD IS ONLY AVAILABLE FOR SINGLE METER INSTALLATION.

 2. CURRENT TRANSFORMERS TO BE INSTALLED AT THE SECONDARY BUSHINGS OF THE TRANSFORMER. BY ALSTIN ENERGY
- 3. METER ENCLOSURE SHALL BE INSTALLED FACING THE FRONT OF THE TRANSFORMER PAD.
- 4 INSTALL METER CONTROL CABLE CONDUIT (1-1/4" SCHEDULE 80 PVC OR RIGID METAL) TO ENTER METER ENCLOSURE AT BOTTOMRIGHT
- 5. ALTERNATE LOCATION: WITH APPROVAL OF THE ELECTRIC METER OPERATION SECTION, THE METER ENCLOSURE MAY BE INSTALLED ON A PERMANENT WALL WITHIN SIGHT (VISIBLE AND NOT MORE THAN 30 FEET) FROM THE TRANSFORMER PAD.
- 6. STEEL BARRIER FOSTS WILL BE REQUIRED WHEN THE TRANSFORMER PAD IS INSTALLED WITHIN 4 FEET OF A TRAFFIC AREA.
- 7. HEIGHT TO CENTER OF THE METERSOCKET OPENING FROM A PERMANENT STANDING SURFACE SHALL
- 8. RUN A #6 GROUND WIRE (EITHER SOLID OR STRANDED) FROM THE SECONDARY COMPARIMENT OF THE PAD MOUNT TRANSFORMER TO THE METER SOCKET. BOND THE GROUND WIRE TO THE METER SOCKET, ANDINSTALL A FULL STRING.

Page 3

N.T.S



3500 DEER CREEK RD PALO ALTO, CA 94304

OF BYTHOUGHT NOMBER. 2010441.22					
DRA	DRAWN BY: HD				
CHE	CKED BY:	RP/EPM			
INST	ALLATION	MANAGER: ROBERT CORDOVA			
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2018441.2

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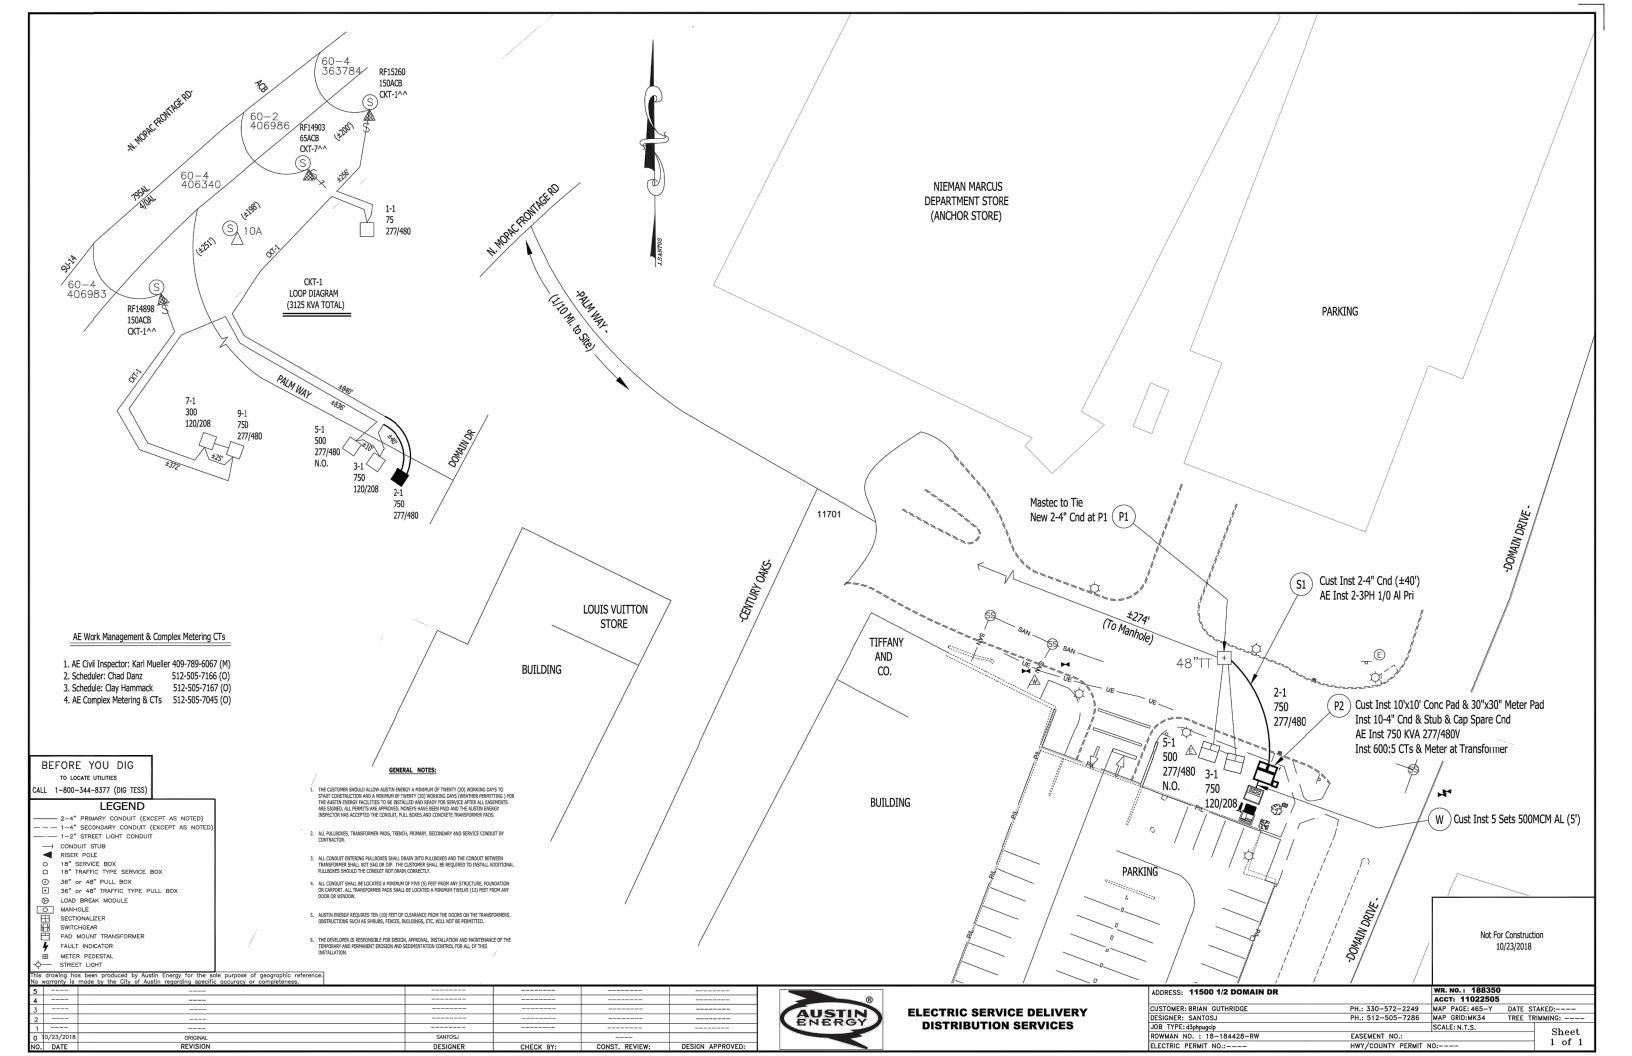
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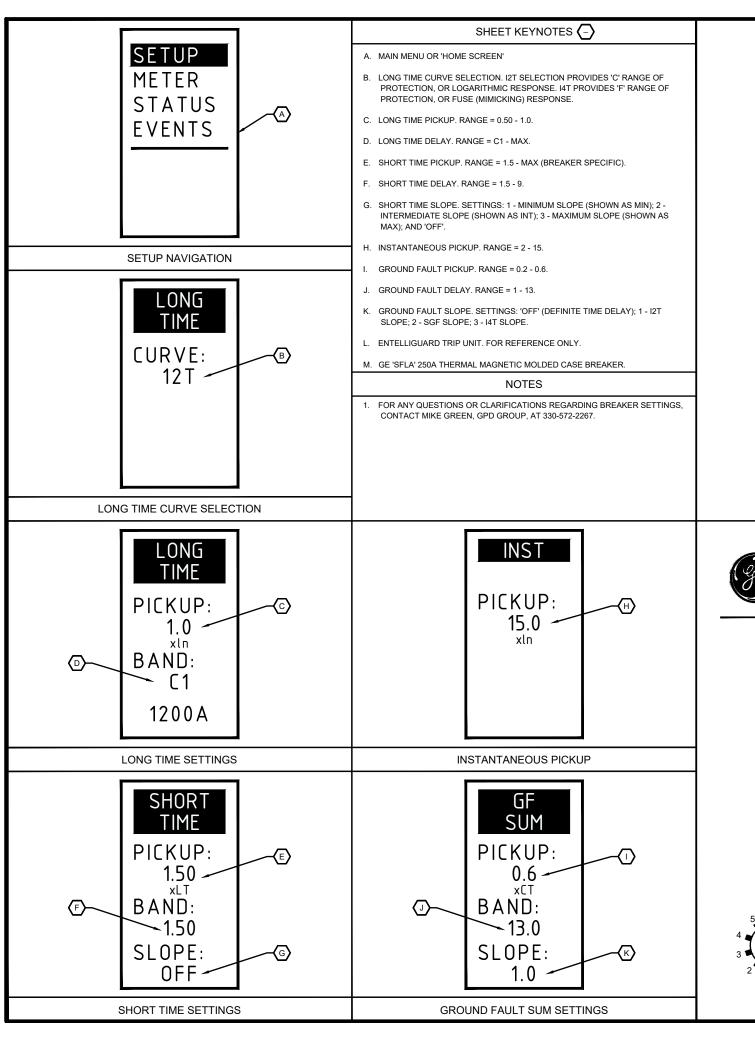
UTILITY DETAILS


SHEET NUMBER

E-8

TRANSFORMER PAD DETAIL N.T.S METER DETAIL





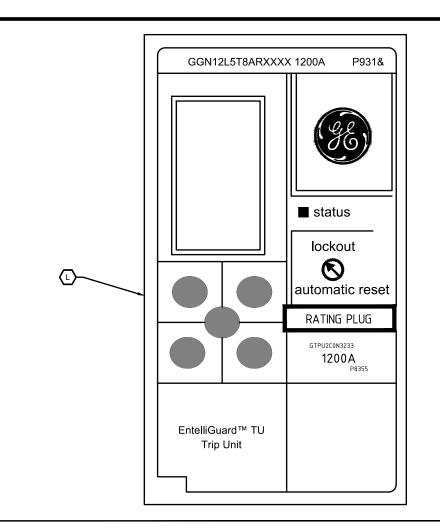





Spectra RMS[™]

60/75DEG C WIRE

TCAL 18

CURRENT LIMITING CIRCUIT BREAKER Cat. NO. SFLA36AT0250 30 AMP MAX

600 VAC ~ 3 POLE RATING PLUG TYPE:

WIRE RANGE: #12 - 3/0 CU


TORQUE:

LUG DATA:

CAT NO:

#12 - #10 35 lb-in #8 - #3 100 lb-in #2 - 3/0 150 lb-in

#12 - 3/0 AL

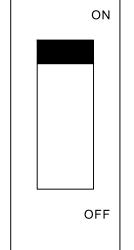

INTERRUPTING RATING RMS SYM. AMPS. 50/60Hz

 VOLTS
 kA

 240
 100

 480
 65

 600
 25



LISTED
CIR BKR FRAME
2 OR 3 POLE UNITS
HID HACR Type
HID 480V MAX
ISSUE ZD-6243

TRIP



<u>Volts</u>	<u>kA</u>	<u>kA</u>	<u>kA</u>
220 / 240	100	50	100
380 / 415	20	15	20
500	8	8	8
690	3	3	3

TYPE SRPF250A SRPF250A200 INST. ADJ. RANGE L0590A 1180A 7500 1535A 940A HI200A 250 A





PD PROJECT NUMBER:	2018441.22

DRAWN B1.	ПО
CHECKED BY:	RP/SPS
INSTALLATION MANAGER:	ROBERT CORDOVA

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ı	GP	D Group	. Professional Corporation
ı	Tex		stration No. 16477
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ı	F	04.17.20	SIGNED AND SEALED
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> > SHEET TITLE

ELECTRICAL BREAKER SETTINGS

SHEET NUMBER

EBS-1



- EXOTHERMIC WELD (2) TWO, #6 AWG BARE TINNED SOLID COPPER CONDUCTORS TO GROUND BAR/LUG. ROUTE CONDUCTORS TO BURIED GROUND RING AND PROVIDE PARALLEL EXOTHERMIC WELD.
- ALL GROUND BARS SHALL BE STAMPED IN TO THE METAL "IF STOLEN DO NOT RECYCLE."
- ALL HARDWARE SHALL BE STAINLESS STEEL 3/8" DIAMETER OR LARGER. ALL HARDWARE 18-8 STAINLESS STEEL INCLUDING LOCK WASHERS, COAT ALL SURFACES WITH AN ANTI-OXIDANT COMPOUND BEFORE
- FOR GROUND BOND TO STEEL ONLY: INSERT A CADMIUM FLAT WASHER BETWEEN LUG AND STEEL, COAT ALL SURFACES WITH AN ANTI-OXIDANT COMPOUND BEFORE MATING.
- DO NOT INSTALL CABLE GROUND KIT AT A BEND AND ALWAYS DIRECT GROUND CONDUCTOR DOWN TO
- NUT & WASHER SHALL BE PLACED ON THE FRONT SIDE OF THE GROUND BAR AND BOLTED ON THE BACK SIDE. INSTALL BLACK HEAT-SHRINKING TUBE, 600 VOLT INSULATION, ON ALL GROUND TERMINATIONS. THE INTENT IS TO WEATHERPROOF THE COMPRESSION CONNECTION.
- THE CONTRACTOR SHALL BE RESPONSIBLE FOR INSTALLING ADDITIONAL GROUND BAR AS REQUIRED, PROVIDING 50% SPARE CONNECTION POINTS
- ENSURE THE WIRE INSULATION TERMINATION IS WITHIN 1/8" OF THE BARREL (NO SHINERS).
- TESLA CHARGERS HAVE INTERNAL HIGH IMPEDANCE GROUND FAULT PROTECTION (10MΩ).
- 10. EMC ELECTROMAGNETIC COMPATIBILITY.
- 11. ALL GROUNDING HARDWARE SUPPLIED AND INSTALLED BY CONTRACTOR.

CADWELD CONNECTIONS



PARALLEL HORIZONTAL CONDUCTORS PARALLEL THROUGH CONNECTION OF HORIZONTAL TYPE PT TYPE HS



HORIZONTAL STEEL SURFACE TO FLAT STEEL SURFACE OR HORIZONTAL PIPE



BURNDY CONNECTIONS



THROUGH CABLE TO GROUND ROD THROUGH CABLE TO TOP OF GROUND ROD TYPE GT



VERTICAL STEEL SURFACE CABLE DOWN AT 45° TO VERTICAL STEEL SURFACE INCLUDING



GREEN STRANDED **INSULATED TYPE 2-YA-2**



HORIZONTAL SPLICE SPLICE OF HORIZONTAL CABLES




CABLE DOWN AT 45 TO RANGE OF VERTICAL PIPES TYPE



TWO HOLE - LONG BARREL LENGTH TYPE

N.T.S

GROUNDING NOTES N.T.S N.T.S N.T.S **DETAIL NOT USED** CADWELD CONNECTION DETAIL 5 3 #6 AWG COPPER EQUIPMENT GROUNDING #12 AWG GND WITHIN

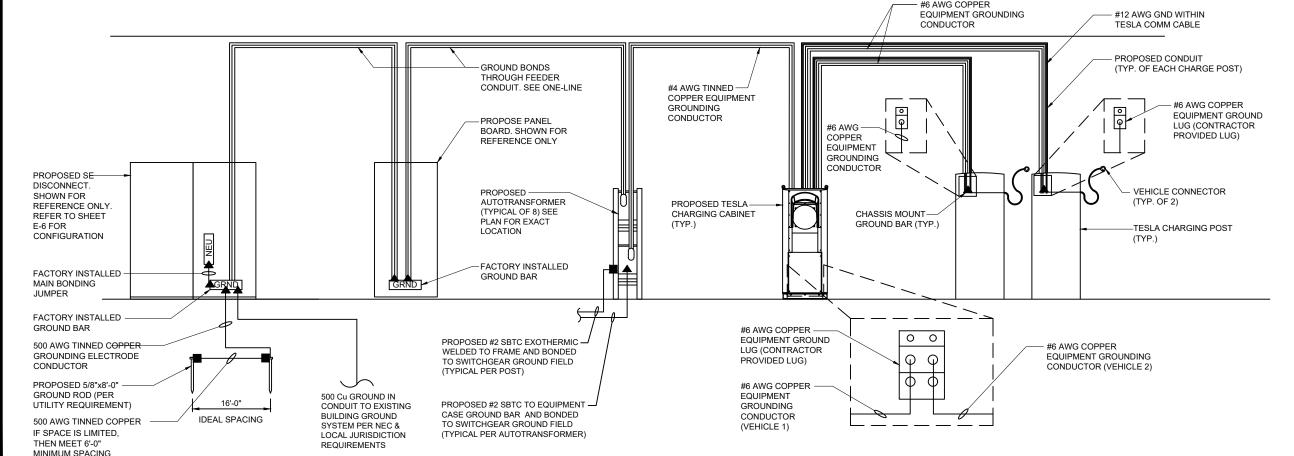

TYPICAL EQUIPMENT GROUNDING SCHEMATIC

3500 DEER CREEK RD PALO ALTO, CA 94304 (650) 681-5000



GPD PROJECT NUMBER:	2018441.22
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CHECKED BY:	RP/EPM
INSTALLATION MANAGER:	ROBERT CORDOVA

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